CHIEF JOSEPH ELEMENTARY STORMWATER RETROFIT

LOWER COLUMBIA ESTUARY PARTNERSHIP PORTLAND, OREGON



PROJECT CONTACT INFORMATION

SITE OWNER:
PORTLAND PUBLIC SCHOOLS
FACILITIES AND ASSET MANAGEMENT
501 N DIXON ST.
PORTLAND, OR 97227
CONTACT: JOANNA EVENSON


CIVIL ENGINEER & SURVEYOR

PARAMETRIX, INC. 5 SE MARTIN LUTHER KING JR BLVD SUITE 400 PORTLAND, OR 97214 (503) 416-6168 SITE

CHIEF JOSEPH ELEMENTARY SCHOOL 2409 N SARATOGA ST. PORTLAND, OR 97217 (503) 916-6255

LCEP PROJECT MANAGER:

LOWER COLUMBIA ESTUARY PARTNERSHIP 400 NE 11TH AVE. PORTLAND, OR 97232 503-226-1565 CONTACT: CHRIS HATHAWAY

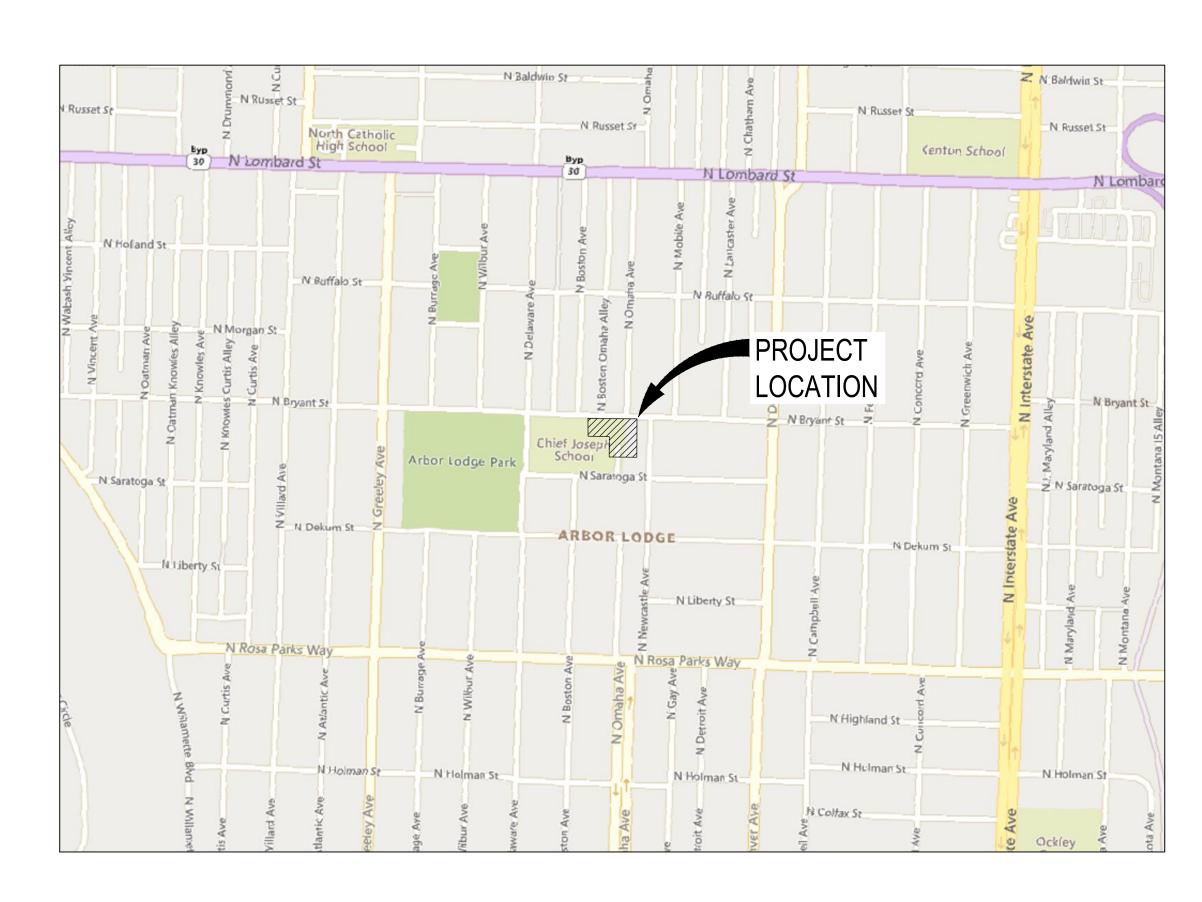







SHEET NUMBER	SHEET TITLE				
G01	COVER SHEET, LOCATION MAPS & DRAWING INDEX				
C01	DEMOLITION & TEMPORARY EROSION AND SEDIMENT CONTROL PLAN				
C02	SITE PLAN				
C03	STORM PROFILES				
C04	NORTH STORMWATER PLANTER DETAILS				
C05	EAST STORMWATER PLANTER DETAILS				
C06	DETAILS SHEET				
C07	DETAILS SHEET				
C08	DETAILS SHEET				
L01	LANDSCAPE PLAN				

GENERAL NOTES:

- HORIZONTAL DATUM IS NAD83(2011), EPOCH 2010.00, OREGON STATE PLAN E NORTH ZONE, INTERNATIONAL FEET BASED ON OREGON REAL-TIME NETWORK (ORGN) GNSS OBSERVATIONS.
- 2. VERTICAL DATUM IS NAVD88 BASED ON OREGON REAL-TIME NETWORK (ORGN) GNSS OBSERVATIONS
- 3. THE OWNER'S REPRESENTATIVE AND THE DESIGN ENGINEER SHALL BE NOTIFIED AT LEAST 24 HOURS PRIOR TO THE START OF CONSTRUCTION. ANY CONSTRUCTION WORK DONE PRIOR TO NOTICE TO PROCEED BEING ISSUED OR WITHOUT INSPECTION WILL BE REJECTED.
- DIMENSIONS, GRADES, ELEVATIONS, EXTENT AND COMPATIBILITY TO THE EXISTING SITE CONDITIONS, AND WITH THE WORK DESCRIBED ON THE ENGINEER'S DRAWINGS. ANY DISCREPANCIES OR UNEXPECTED CONDITIONS THAT AFFECT OR CHANGE THE WORK DESCRIBED IN THE CONTRACT DOCUMENTS SHALL BE BROUGHT TO THE ENGINEER'S ATTENTION IMMEDIATELY. CONTRACTOR SHALL NOT PROCEED WITH ANY OF THE WORK IN THE AREA OF DISCREPANCIES UNTIL ALL SUCH DISCREPANCIES ARE RESOLVED. IF THE CONTRACTOR CHOOSES TO DO SO, THEN IT IS UNDERSTOOD THAT THE CONTRACTOR IS CHOOSING TO PROCEED AT THE CONTRACTOR'S OWN RISK AND SHALL INCUR ALL COSTS, IF ANY TO RESOLVE THE ISSUES TO THE SATISFACTION OF THE ENGINEER.
- 5. IT SHALL BE THE RESPONSIBILITY OF THE CONTRACTOR TO CONTACT OREGON UTILITY NOTIFICATION CENTER AT 811 OR 1-800-332-2344 AT LEAST 48 BUSINESS-DAY HOURS PRIOR TO THE START OF CONSTRUCTION FOR THE LOCATION OF POWER, GAS, CABLE TV AND TELEPHONE UNDERGROUND FACILITIES. THE CONTRACTOR WILL ALSO BE RESPONSIBLE FOR CONTACTING THE APPROPRIATE PUBLIC AGENCY FOR THE LOCATION OF UNDERGROUND FACILITIES.
- 6. CONTRACTOR TO VERIFY LOCATION OF EXISTING UTILITIES PRIOR TO CONSTRUCTION. OREGON LAW REQUIRES YOU TO FOLLOW RULES ADOPTED BY THE OREGON UTILITY NOTIFICATION CENTER. THOSE RULES ARE SET FORTH IN OAR 952-001-0010 THROUGH 952-001-0090. YOU MAY OBTAIN COPIES OF THE RULES BY CALLING THE CENTER. THE TELEPHONE NUMBER FOR THE OREGON UTILITY NOTIFICATION CENTER IS (800)332-2344 OR 811.
- 7. ALL UNSUITABLE SOILS MATERIALS, RUBBISH AND DEBRIS RESULTING FROM GRADING OPERATIONS SHALL BE REMOVED FROM THE JOB SITE AND DISPOSED OF PROPERLY.
- 8. THE CONTRACTOR SHALL EMPLOY ALL LABOR, EQUIPMENT, AND METHODS REQUIRED TO PREVENT DUST IN AMOUNTS DAMAGING TO PROPERTY, CULTIVATED VEGETATION AND DOMESTIC ANIMALS OR CAUSING A NUISANCE TO PERSONS OCCUPYING BUILDINGS IN THE VICINITY OF THE JOB SITE. THE CONTRACTOR SHALL BE RESPONSIBLE FOR ANY DAMAGE CAUSED BY DUST RESULTING FROM CONSTRUCTION.
- 9. THE CONTRACTOR SHALL FOLLOW ALL APPLICABLE INDUSTRIAL SAFETY REGULATIONS. THE ENGINEER, AND THE OWNER SHALL NOT BE RESPONSIBLE FOR ENFORCING SAFETY REGULATIONS.
- 10. CONTRACTOR TO NOTIFY ENGINEER FOR APPROVAL IF ANY MATERIALS DIFFER FROM THOSE DETAILED IN THESE PLANS.
- 11. ALL WORK SHALL BE PERFORMED BY A CITY OF PORTLAND APPROVED CONTRACTOR.
- 12. ALL WORK AND MATERIALS SHALL CONFORM TO THESE PLANS, OR WHERE NOT SPECIFIED, THE APPLICABLE PROVISIONS OF THE LATEST CITY OF PORTLAND STANDARD CONSTRUCTION SPECIFICATIONS OR STORMWATER MANAGEMENT MANUAL.



low what's below. 10 Call before you dig.

100 % SUBMITTAL

REVISIONS	DATE	BY	DESIGNED S. SOKOL
			DRAWN E. JOHNSON, A. FLORES-RAMIREZ
			CHECKED
			C. BUITRAGO
			APPROVED

ONE INCH AT FULL SCALE. IF NOT, SCALE ACCORDINGLY
FILE NAME XPO3324010C-G01-COVER
JOB No. 273-3324-010
DATE 10/31/25





CHIEF JOSEPH ELEMENTARY
STORMWATER RETROFIT

PORTLAND, OREGON

COVER SHEET, LOCATION MAPS AND DRAWING INDEX

DRAWING NO.

1 OF 10

G01

EROSION AND SEDIMENT CONTROL NOTES:

- A. 24-HOUR ONSITE EROSION AND SEDIMENT CONTROL MANAGER CONTACT _ PHONE NO: ___
- B. APPROVAL OF THIS EROSION, SEDIMENT AND POLLUTION CONTROL PLAN (ESPCP) DOES NOT CONSTITUTE AN APPROVAL OF PERMANENT ROAD OR DRAINAGE DESIGN (E.G., SIZE AND LOCATION OF ROADS, PIPES, RESTRICTORS, CHANNELS, RETENTION BEST MANAGEMENT PRACTICES [BMPS], OR UTILITIES).
- C. THE IMPLEMENTATION OF THIS ESPCP AND THE CONSTRUCTION, MAINTENANCE, REPLACEMENT, AND UPGRADING OF THESE ESPCP BMPS IS THE RESPONSIBILITY OF THE RESPONSIBLE PARTY UNTIL ALL CONSTRUCTION IS COMPLETED AND APPROVED PERMANENT STABILIZATION IS ESTABLISHED.
- D. THE BOUNDARIES OF THE CLEARING LIMITS SHOWN ON THIS PLAN SHALL BE CLEARLY FLAGGED IN THE FIELD PRIOR TO CONSTRUCTION. DURING THE CONSTRUCTION PERIOD, NO DISTURBANCE BEYOND THE FLAGGED CLEARING LIMITS SHALL BE PERMITTED. THE FLAGGING SHALL BE MAINTAINED BY THE RESPONSIBLE PARTY FOR THE DURATION OF CONSTRUCTION. EXCEEDING THE APPROVED LIMITS OF DISTURBANCE MAY RESULT IN ADDITIONAL PERMITTING REQUIREMENTS, PERMIT REVISIONS, STOP WORK ORDERS, OR OTHER ENFORCEMENT ACTIONS.
- E. THE ESPCP BMPS SHOWN ON THIS PLAN MUST BE CONSTRUCTED PER CITY STANDARDS AND MADE FUNCTIONAL PRIOR TO GROUND-DISTURBING ACTIVITIES, AND IN SUCH A MANNER AS TO ENSURE THAT SEDIMENT AND SEDIMENT-LADEN WATER DO NOT ENTER THE DRAINAGE SYSTEM, ROADWAYS, OR VIOLATE APPLICABLE WATER STANDARDS. THE INITIAL CLEARING MUST BE THE MINIMUM REQUIRED TO INSTALL ESPCP BMPS.
- F. THE ESPCP BMPS SHOWN ON THIS PLAN ARE THE MINIMUM REQUIREMENTS FOR ANTICIPATED SITE CONDITIONS. DURING THE CONSTRUCTION PERIOD, THESE ESPCP BMPS SHALL BE UPGRADED AS NEEDED FOR UNEXPECTED STORM EVENTS OR SITE CONDITIONS AND TO ENSURE THAT SEDIMENT AND SEDIMENT-LADEN WATER DO NOT LEAVE THE SITE. ADDITION AND REMOVAL OF BMPS SHOULD BE DOCUMENTED IN THE DAILY INSPECTION LOG AND, IN CASES OF ESPCP REVISION, ON THE REVISED ESPCP.
- G. FUELS, OILS, SOLVENTS, HAZARDOUS CHEMICALS, AND OTHER TOXIC MATERIALS SHALL BE STORED IN ACCORDANCE WITH THEIR LISTING AND ARE NOT TO CONTAMINATE SOILS AND SURFACE WATERS. ALL APPROVED STORAGE CONTAINERS ARE TO BE PROTECTED FROM THE WEATHER. SPILLS MUST BE CLEANED UP IMMEDIATELY AND DISPOSED OF IN A PROPER MANNER. SPILLS MAY NOT BE WASHED INTO THE DRAINAGE SYSTEM, NOR BE ALLOWED TO SETTLE OR INFILTRATE INTO SOIL
- H. OFFSITE RELEASE OF FUEL, OILS, SOLVENTS, HAZARDOUS CHEMICALS, SEDIMENT, TRASH, DEBRIS, OR OTHER SUBSTANCES RESULTING FROM CONSTRUCTION ACTIVITIES IS NOT ALLOWED. ALL SPILLS IN EXCESS OF REPORTABLE QUANTITIES SHALL BE REPORTED TO BUREAU OF ENVIRONMENTAL SERVICES SPILL RESPONSE, 503-823-7180.
- SIGNAGE SHALL BE POSTED ON THE SITE OF THE PERMITTED GROUND-DISTURBING ACTIVITY THAT IDENTIFIES THE CITY'S EROSION CONTROL COMPLAINT HOTLINE NUMBER OR THE RESPONSIBLE CITY PROJECT MANAGER/INSPECTOR.
- J. BETWEEN OCTOBER 1 AND APRIL 30, ALL DENUDED SITES SHALL BE PROVIDED WITH TEMPORARY SOIL STABILIZATION AS SOON AS PRACTICABLE, BUT IN NO CASE MORE THAN 2 DAYS AFTER GROUND-DISTURBING ACTIVITY OCCURS.
- K. BETWEEN MAY 1 AND SEPTEMBER 30, TEMPORARY EROSION AND SEDIMENT CONTROL BMPS TO REDUCE DUST AND SEDIMENT TRANSPORT SHALL BE APPLIED AS SOON AS PRACTICABLE, BUT IN NO CASE MORE THAN 7 DAYS AFTER GROUND-DISTURBING ACTIVITY OCCURS.

INSPECTION AND MAINTENANCE STANDARD NOTES


- A. THE ESPCP BMPS SHOWN ON THIS PLAN ARE THE MINIMUM REQUIREMENTS FOR ANTICIPATED SITE CONDITIONS. DURING THE CONSTRUCTION PERIOD, THESE ESPCP BMPS SHALL BE UPGRADED AS NEEDED FOR UNEXPECTED STORM EVENTS OR SITE CONDITIONS AND TO ENSURE THAT SEDIMENT AND SEDIMENT-LADEN WATER DO NOT LEAVE THE SITE. ADDITION AND REMOVAL OF BMPS SHOULD BE DOCUMENTED IN THE DAILY INSPECTION LOG AND, IN CASES OF ESPCP REVISION, ON THE REVISED ESPCP.
- B. THE ESPCP BMPS ON ACTIVE SITES SHALL BE INSPECTED DAILY BY THE ONSITE EROSION AND SEDIMENT CONTROL MANAGER, AND THE EROSION, SEDIMENT, AND POLLUTANT CONTROL BMPS SHALL BE MAINTAINED, ADJUSTED, REPAIRED, AND REPLACED AS NECESSARY, TO ENSURE THAT THE BMPS ARE FUNCTIONING PROPERLY.
- C. THE ESPCP BMPS ON INACTIVE SITES SHALL BE INSPECTED AT LEAST ONCE A MONTH AND WITHIN 24 HOURS FOLLOWING A STORM EVENT, AND EROSION, SEDIMENT, AND POLLUTANT CONTROL BMPS SHALL BE MAINTAINED, ADJUSTED, REPAIRED, AND REPLACED AS NECESSARY, TO ENSURE THAT THE BMPS ARE FUNCTIONING PROPERLY.
- TEMPORARY STABILIZATION BMPS SHALL BE MAINTAINED UNTIL PERMANENT STABILIZATION BMPS ARE ESTABLISHED.
- ALL INSPECTIONS CONDUCTED BY THE ONSITE EROSION AND SEDIMENT CONTROL MANAGER SHALL BE NOTED IN AN INSPECTION LOG INDICATING THE DATE AND TIME OF THE INSPECTION. THE INSPECTION LOG SHALL BE MADE AVAILABLE TO THE DIRECTOR OR DIRECTOR'S DELEGATE UPON REQUEST.
- F. AFTER ESPCP BMP INSTALLATION BUT PRIOR TO PERFORMING OTHER GROUND-DISTURBING ACTIVITIES, A PRECONSTRUCTION EROSION CONTROL INSPECTION SHALL BE APPROVED. THIS INSPECTION MAY BE OBTAINED BY CALLING 503-823-7000 AND REQUESTING A #200 INSPECTION USING THE ASSIGNED INTERACTIVE VOICE RESPONSE (IVR) NUMBER OR PERMIT NUMBER.
- G. AFTER INSTALLATION OF PERMANENT STABILIZATION BMPS, A PERMANENT EROSION CONTROL BMPS INSPECTION SHALL BE APPROVED. A PERMANENT EROSION CONTROL INSPECTION MAY BE OBTAINED BY CALLING 503-823-7000 AND REQUESTING A #210 INSPECTION USING THEPERMIT IVR NUMBER.

PERMANENT STABILIZATION STANDARD NOTES

- A. TEMPORARY STABILIZATION BMPS SHALL BE MAINTAINED UNTIL PERMANENT STABILIZATION BMPS ARE ESTABLISHED.
- B. REPLACEMENT VEGETATIVE COVER MUST NOT INCLUDE PLANTS IN EITHER THE NUISANCE OR THE PROHIBITED PLANT LIST, AS SET FORTH IN THE CITY OF PORTLAND PLANT LIST. COMPLIANCE WITH STATE AND FEDERAL PERMITS STANDARD

COMPLIANCE WITH STATE AND FEDERAL PERMITS STANDARD NOTE

A. COMPLIANCE WITH PORTLAND CITY CODE TITLE 10 AND APPROVAL OF AN ESPCP DOES NOT RELIEVE THE OPERATOR FROM REQUIREMENTS SET FORTH BY OTHER STATE, FEDERAL, AND LOCAL STANDARDS OR REQUIREMENTS. IT IS THE DUTY OF THE RESPONSIBLE PARTY TO OBTAIN PERMIT COVERAGE AND ENSURE COMPLIANCE WITH ALL REGULATORY AGENCIES, PERMIT CONDITIONS, AND PERFORMANCE STANDARDS.

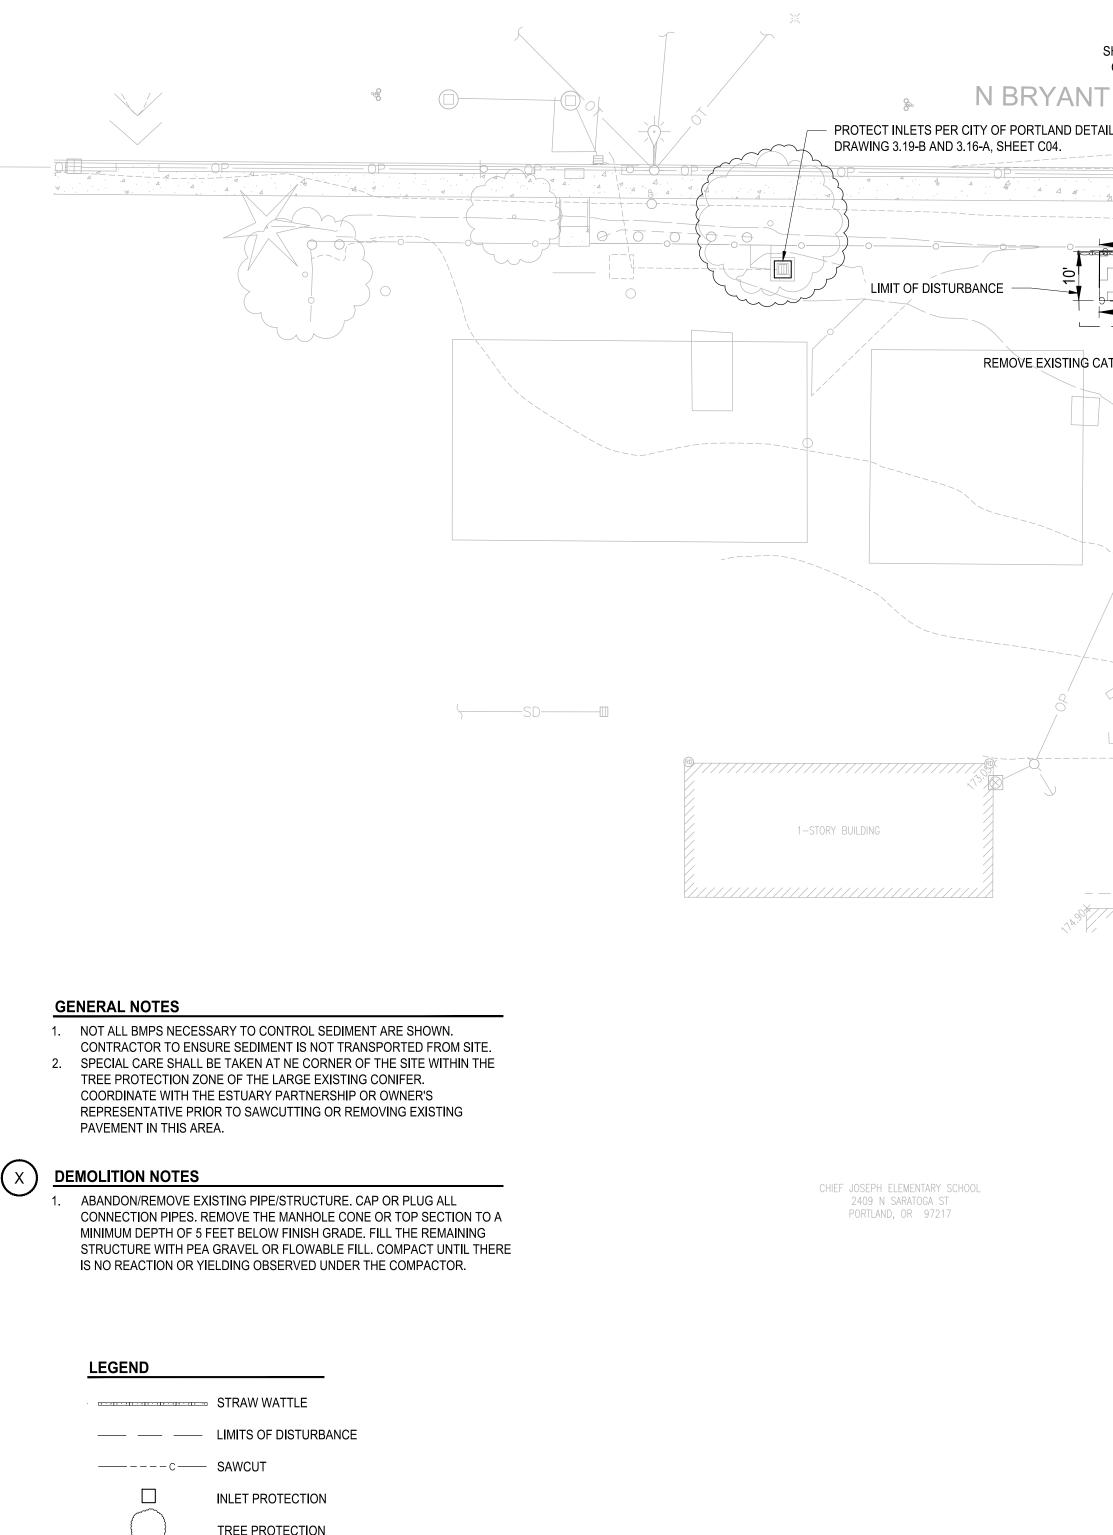







PORTLAND, OREGON

PROTECT EXISTING TREES PER DETAIL P582 (TYP),

INSTALL WATTLES INSIDE FENCE (TYP)

SHEET C04. ROOT PROTECTION ZONE IS 1 FT. PER 1 IN.

N BRYANT ST

REMOVE EXISTING CATCHBASIN AND STORM PIPE 1

LIMIT OF DISTURBANCE

2409 N SARATOGA ST

OF TREE DIAM. MEASURED 4.5 FT. OFF/THE GROUND.

DEMOLITION & TEMPORARY EROSION AND SEDIMENT CONTROL PLAN

N SARATOGA ST

DEMOLISH SIDEWALK AND

CURB TO NEAREST JOINT

PRESERVE AND PROTECT

EXISTING FENCE (TYP)

REMOVE EXISTING PIPE

ABANDON EXISTING CATCH BASIN.

REMOVE AND DISPOSE

OF EXISTING BACKSTOP

ABANDON EXISTING DRYWELL/CESPOOL \(1

SAWCUT AND DEMOLISH EXSTING

REMOVE EXISTING CATCHBASIN AND STORM PIPE

FF=175.07 —

PAVEMENT WITHIN SAWCUT LINES (TYP)

RELOCATE GAGA BALL PIT.

WITH ESTUARY PARTNERSHIP.

COORDINATE REINSTALL LOCATION

2-STORY BUILDING

DRAWING NO. 2 OF 10 C01

100 % SUBMITTAL

DESIGNED S. SOKOL > | REVISIONS DRAWN . JOHNSON, A. FLORES-RAMIREZ C. BUITRAGO APPROVED

ONE INCH AT FULL SCALE IF NOT, SCALE ACCORDINGLY P03324010C-C01-TESC 273-3324-010






TREE PROTECTION

PAVEMENT REMOVAL



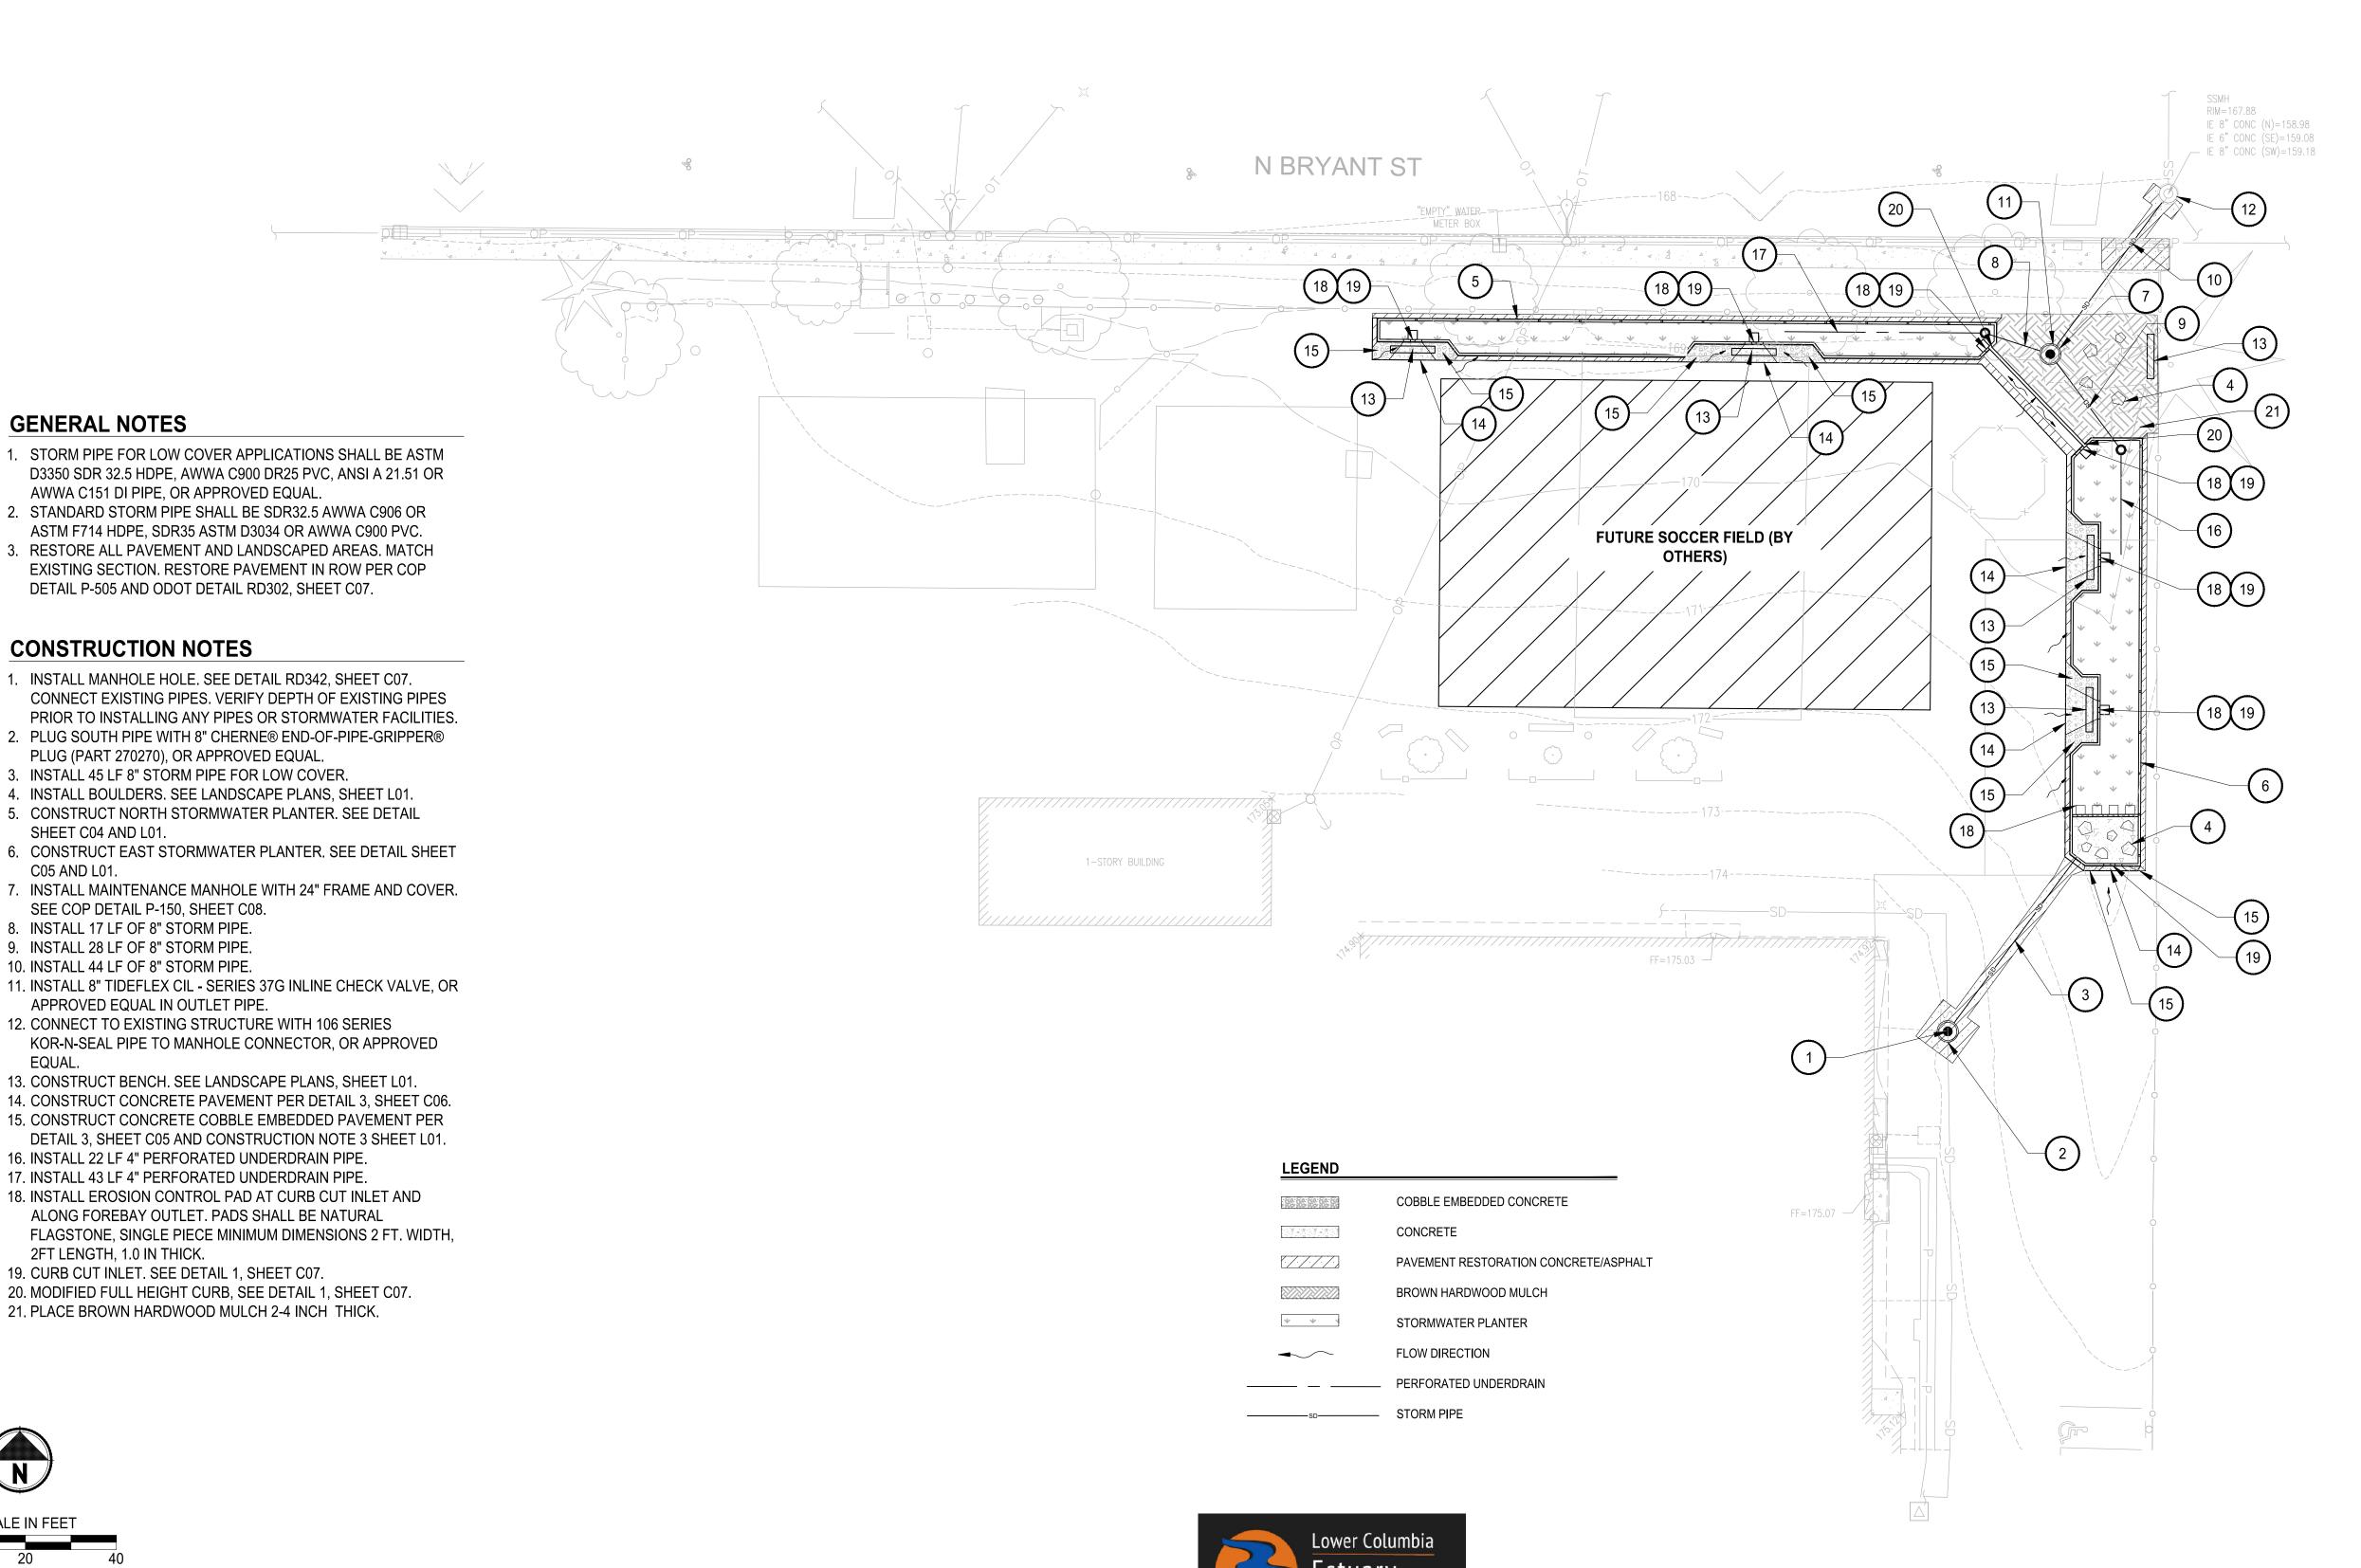

	REVISIONS	DATE	BY	S. SOKOL
SITE				DRAWN FLORES DANIBEZ
C02				E. JOHNSON, A. FLORES—RAMIREZ
. <u>:</u>				CHECKED C. BUITRAGO
LAYOU				APPROVED

GENERAL NOTES

(X) CONSTRUCTION NOTES

SHEET C04 AND L01.

SEE COP DETAIL P-150, SHEET C08. 8. INSTALL 17 LF OF 8" STORM PIPE. 9. INSTALL 28 LF OF 8" STORM PIPE.

10. INSTALL 44 LF OF 8" STORM PIPE.

2FT LENGTH, 1.0 IN THICK.

C05 AND L01.

ONE INCH AT FULL SCALE IF NOT, SCALE ACCORDINGLY XP03324010C-SITE PLAN 273-3324-010 10/31/25







CHIEF JOSEPH ELEMENTARY STORMWATER RETROFIT PORTLAND, OREGON


SITE PLAN

DRAWING NO. 3 OF 10

100 % SUBMITTAL

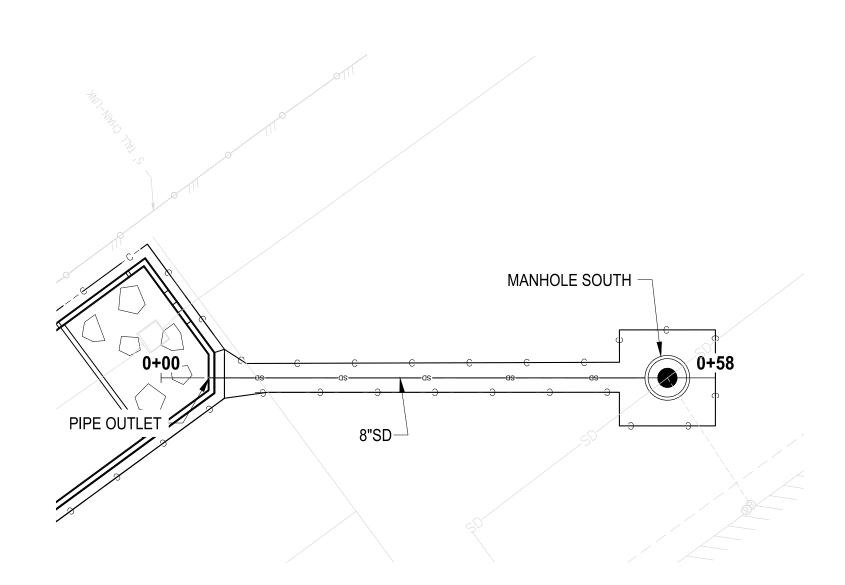

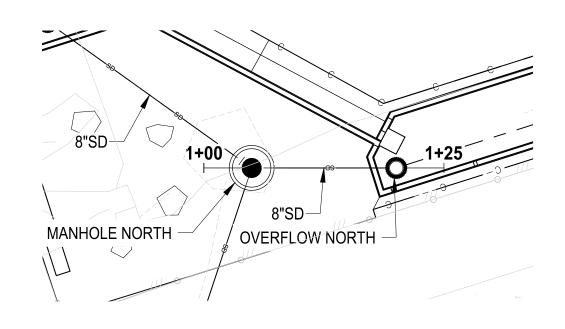

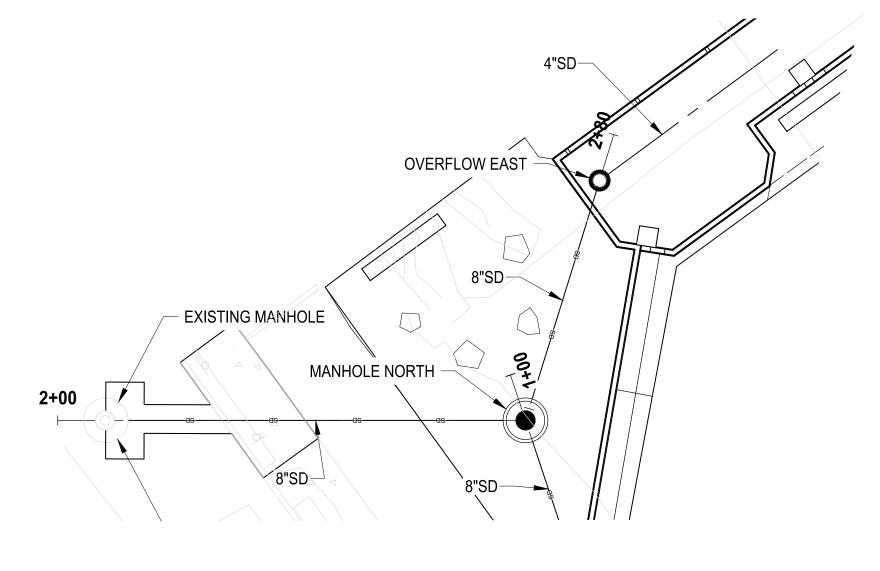


PLAN VIEW NORTH 2+00




PLAN VIEW SOUTH

1" = 10'



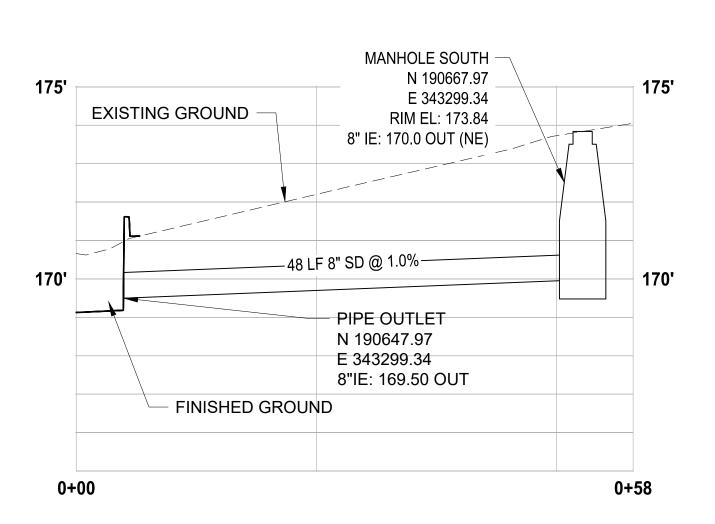

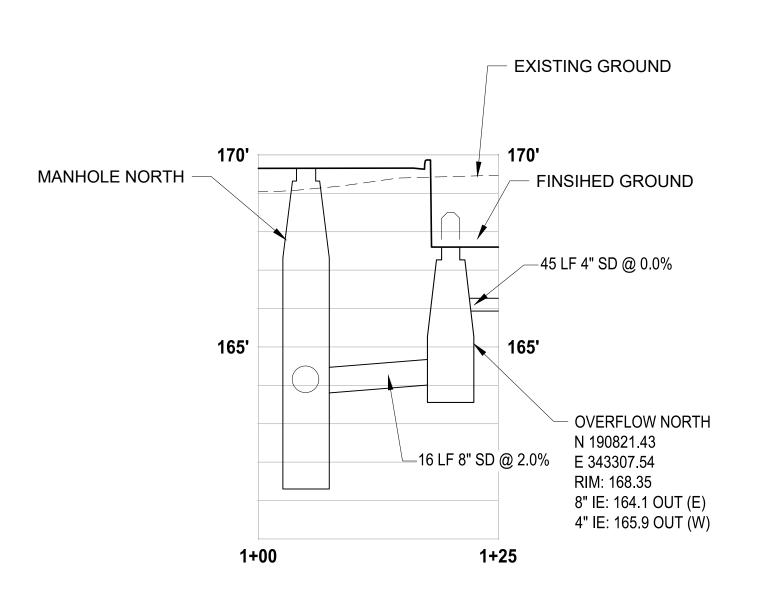

PLAN VIEW NORTH 1+00

1" = 10'

FINISHED GROUND EXISTING GROUND EXISTING MANHOLE N 190852.01 MANHOLE NORTH E 343347.79 N 190816.79 RIM EL: 167.84 E 343321.87 8" IE: 159.3 IN (SW) RIM EL: 169.65 8" IE: 163.8 IN (W) —23 LF 4" SD @ 0.0% 8" IE: 163.8 IN (SE) 8" IE: 162.8 OUT (NE) INSTALL OUTLET CHECK VALVE PER NOTE 11 SHEET C02 SUMP: 161.8 165' 165' ____27 LF 8" SD @ 2.0%___ KOR N SEAL CONNECTION AT EXISTING STRUCTURE **OVERFLOW EAST** N 190795.77 160' E 343337.42 RIM EL: 169.17 4" IE: 166.8 OUT (S) _ 8" IE: 164.3 OUT (NW) 2+00 2+80

SOUTH PROFILE

1" = 10' HORIZONTAL

1" = 40' VERTICAL

NORTH PROFILE 1+00

1" = 10' HORIZONTAL

1" = 40' VERTICAL

NORTH PROFILE 2+00

1" = 10' HORIZONTAL 1" = 40' VERTICAL

REVISIONS

DATE
BY
DESIGNED
S. SOKOL

DRAWN
E. JOHNSON, A. FLORES-RAMIREZ

CHECKED
C. BUITRAGO

APPROVED

ONE INCH AT FULL SCALE.
IF NOT, SCALE ACCORDINGLY

FILE NAME

XPO3324010C-C05-PROFILE

JOB No.

273-3324-010

DATE

10 /31 /25





CHIEF JOSEPH ELEMENTARY
STORMWATER RETROFIT
PORTLAND, OREGON

100 % SUBMITTAL

STORM PROFILES

DRAWING NO.
4 OF 10

NTS

273-3324-010

APPROVED


RENEW: 06/30/2026


GENERAL NOTES


- 1. TOP OF WALL ELEVATIONS TO MATCH EXISTING TOP OF PAVEMENT PLUS 4 INCHES.
- 2. BLENDED SOIL SHALL BE PORTLAND BES "HIGH-FINES" BLEND. REFER TO BES SWMM WEBSITE'S "STORMWATER FACILITY BLENDED SOIL VENDOR HAULING LIST" FOR SUPPLIERS. (https://www.portland.gov/bes/stormwater/documents/stormwater-facility-blended-soil-vendors-and-haulers/download)

(X) CONSTRUCTION NOTES

- 1. INSTALL 4-INCH PERFORATED HDPE UNDERDRAIN PIPING MEETING ASTM F667, SUCH AS PERFORATED CORTEX, OR APPROVED EQUAL.
- 2. INSTALL 24 IN BEEHIVE OVERFLOW GRATE PER DETAIL, P-309, SHEET C07. INSTALL 4 IN UV-RESISTANT (OR PAINTED) PVC ELBOWS AND BUSHING TO REDUCE TO $1\frac{1}{2}$ IN DIAMETER. INSTALL 4 IN UV RESISTANT (OR PAINTED) FLEXIBLE COUPLER AT CONNECTION WITH PERFORATED PIPE.
- 3. INSTALL EROSION CONTROL PAD AT CURB CUT INLET AND ALONG FOREBAY OUTLET. PADS SHALL BE NATURAL FLAGSTONE, SINGLE PIECE MINIMUM DIMENSIONS 2 FT. WIDTH, 2FT LENGTH, 1.0 IN THICK.
- 4. CURB CUT INLET. SEE DETAIL 1, SHEET C07.
- 5. INSTALL EROSION CONTROL PADS PER CONSTRUCTION NOTE 3 ALONG THE FULL LENGTH OF THE FOREBAY.
- 6. INSTALL CURB NOTCH EVERY 9' ON FENCE SIDE WALL PER DETAIL P-307, SHEET C07.

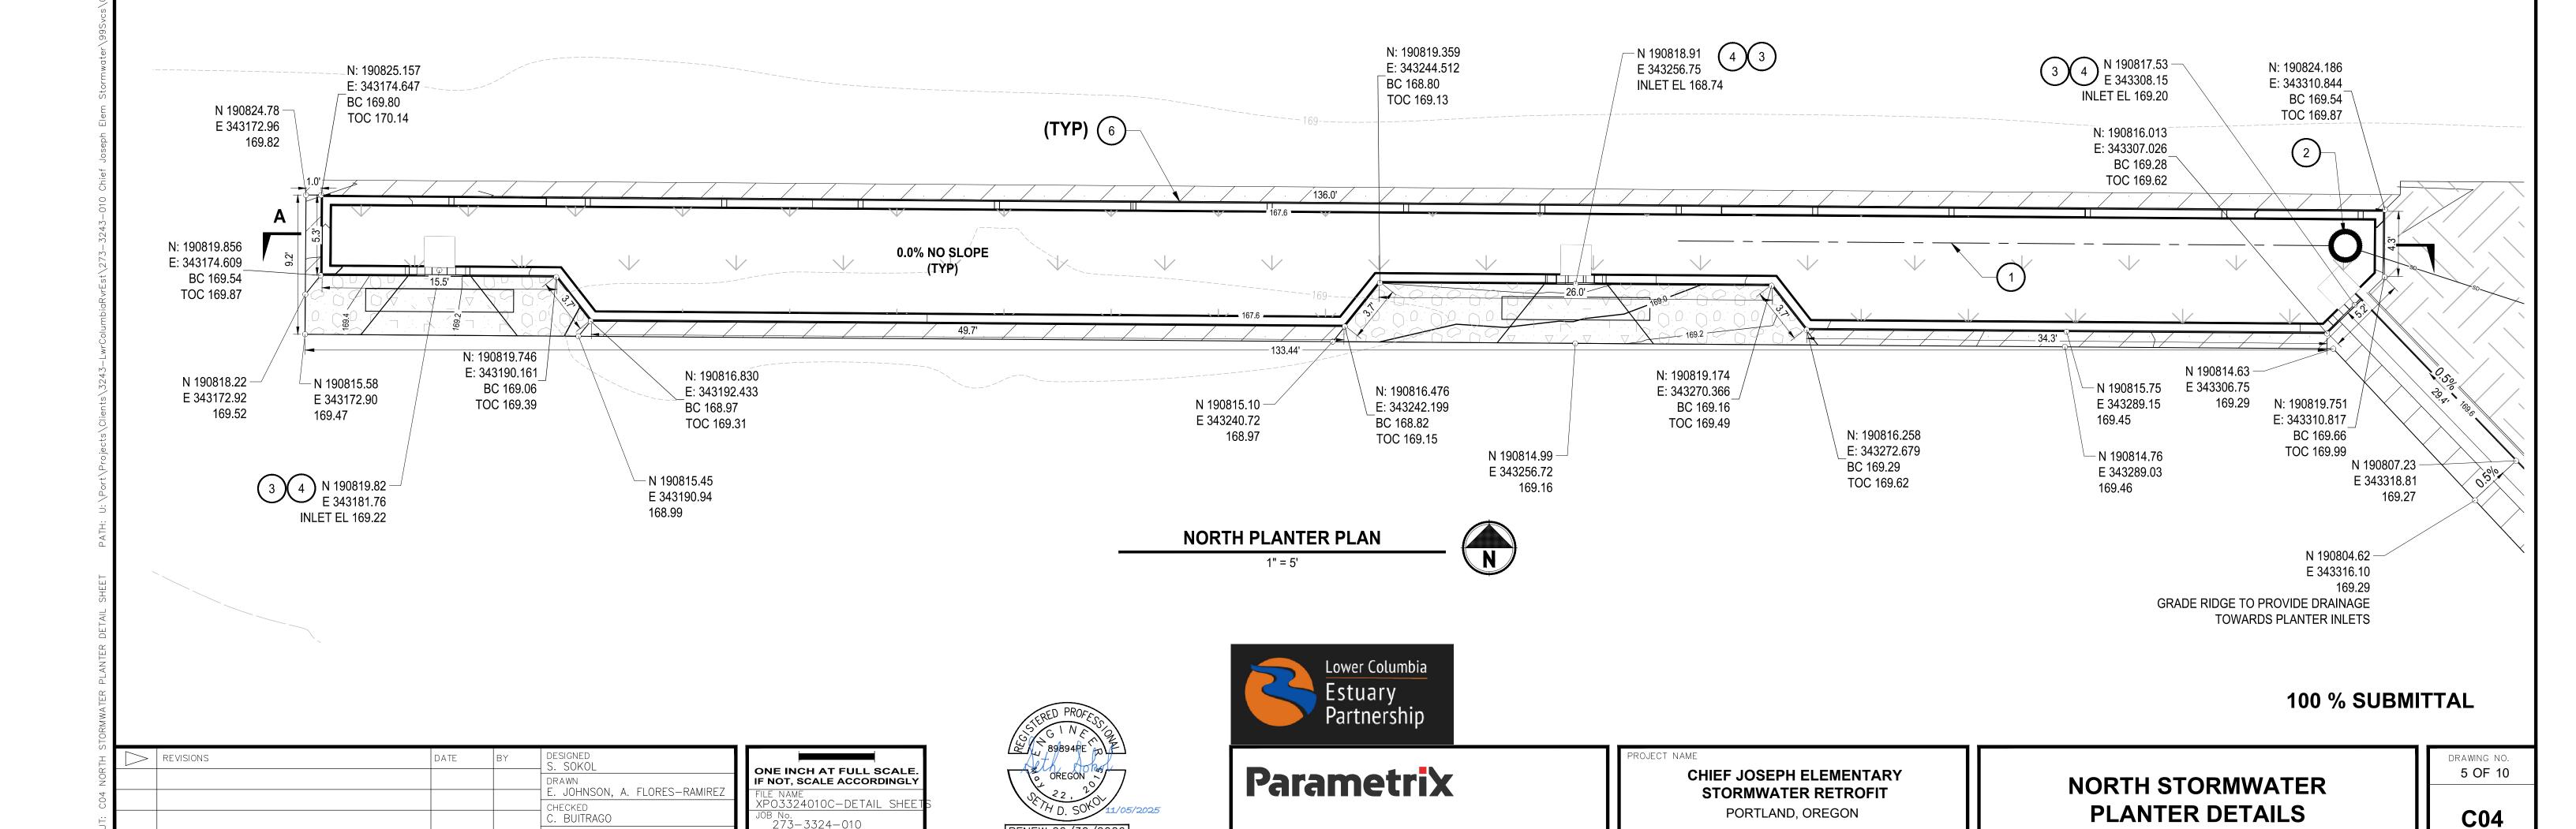

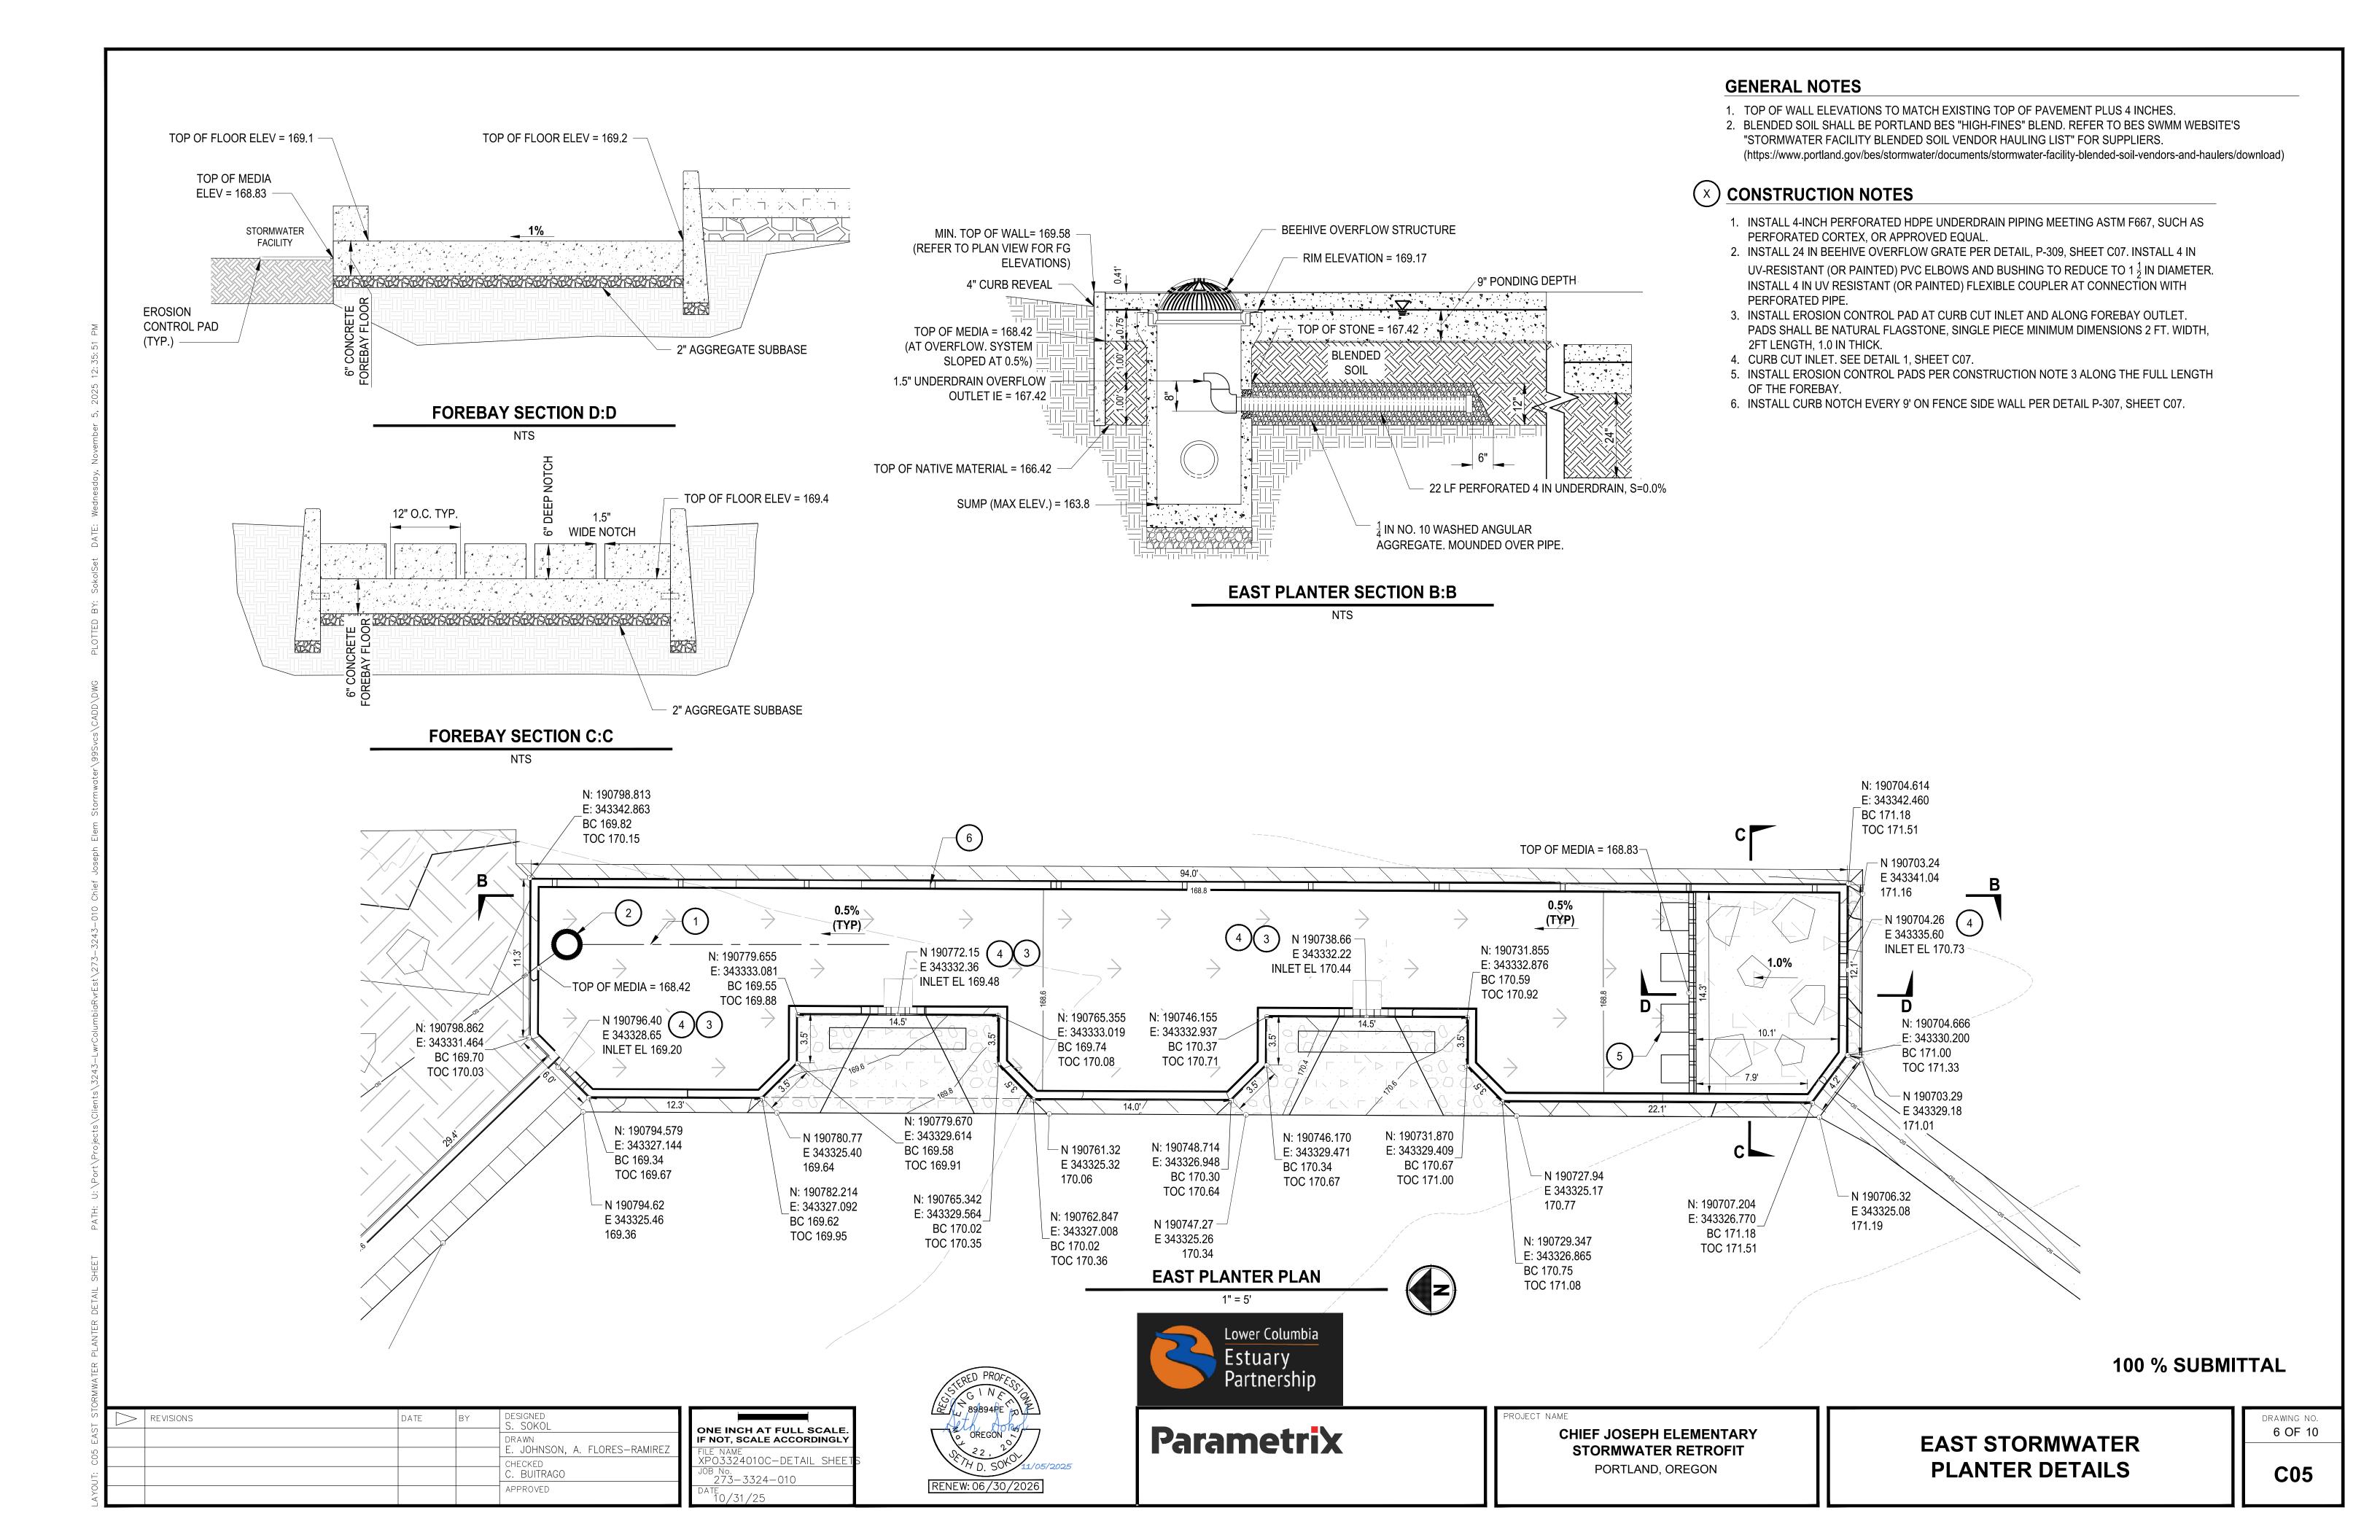

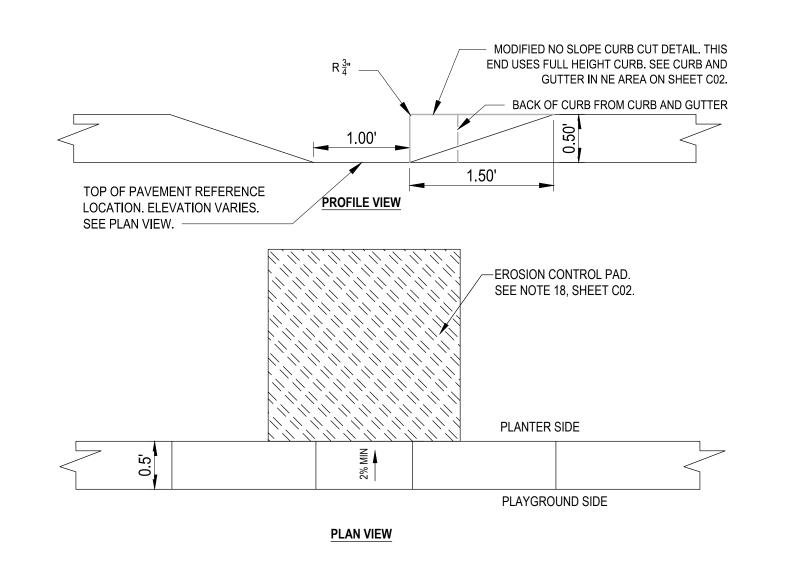

STORMWATER FACILITY SOIL

BENCHES TO DEPTH REQUIRED FOR PLANTER WALL CONSTRUCTION.

A" CURB REVEAL

BROOM FINISH ALL EXPOSED CONCRETE SURFACES

STORMWATER FACILITY

6:1 BATTER

(TYP) 6' CONCRETE REINFORCED RETAINING WALL WITH #4 @18' O.C. VERTICAL AND #4 @15' O.C. HORIZONTAL


2" AGGREGATE SUBBASE

MIN. 5" COMMERCIAL -1"-3" RIVER ROCK COBBLE MIN. 5" COMMERCIAL CONCRETE CONCRETE -MAX 1/4" REVEAL MIN. 4" 1"-0" or $\frac{3}{4}$ "-0" GRANULAR BASE. MIN. 4" 1"-0" or $\frac{3}{4}$ "-0" GRANULAR BASE. COMPACT TO MIN. 90 PERCENT COMPACT TO MIN. 90 PERCENT OF MAXIMUM DENSITY ACCORDING OF MAXIMUM DENSITY ACCORDING TO AASHTO T 99. TO AASHTO T 99. WITHOUT EMBEDDED COBBLE. WITH EMBEDDED COBBLE.


1 TYPICAL CURB CUT PLAN & PROFILE DETAIL


PLANTER WALL DETAIL

3 TYPICAL PORTLAND CEMENT CONCRETE PAVEMENT SECTION

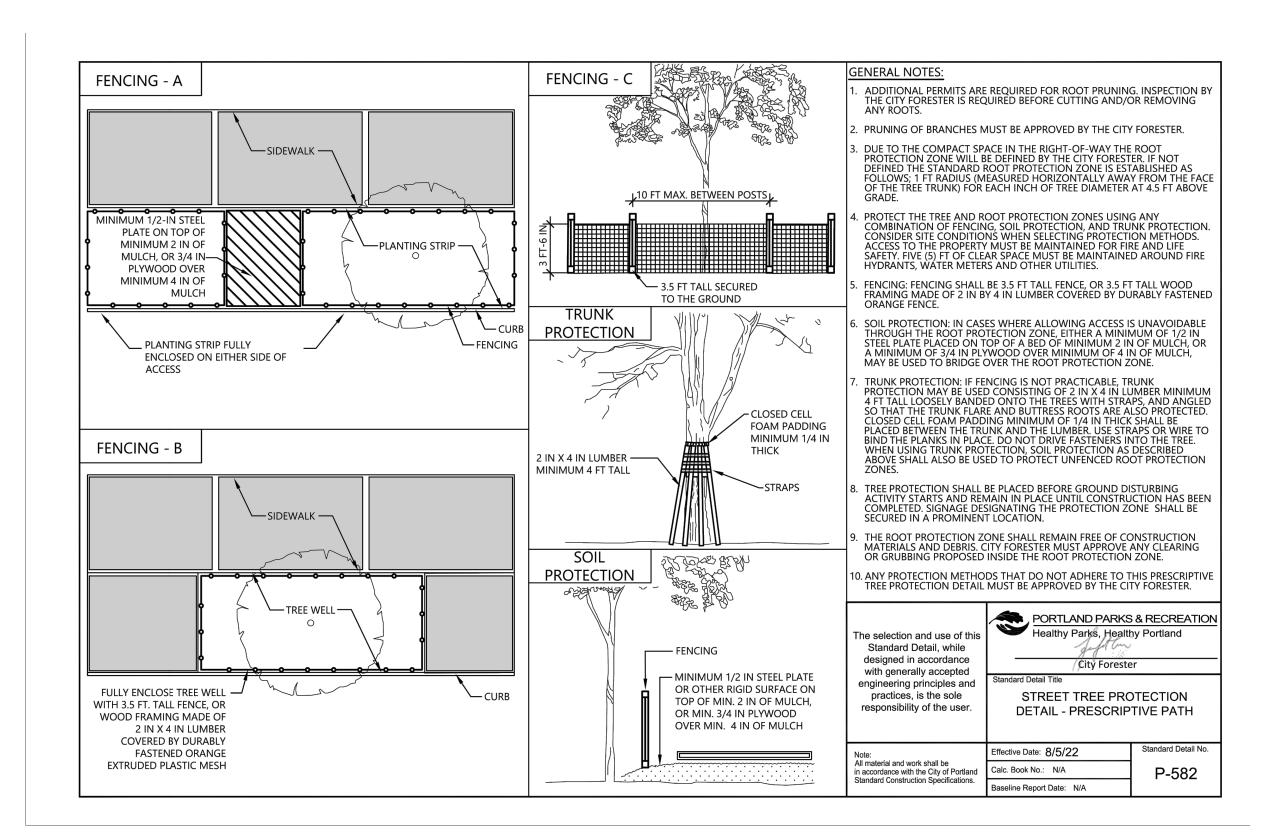

1"=1'

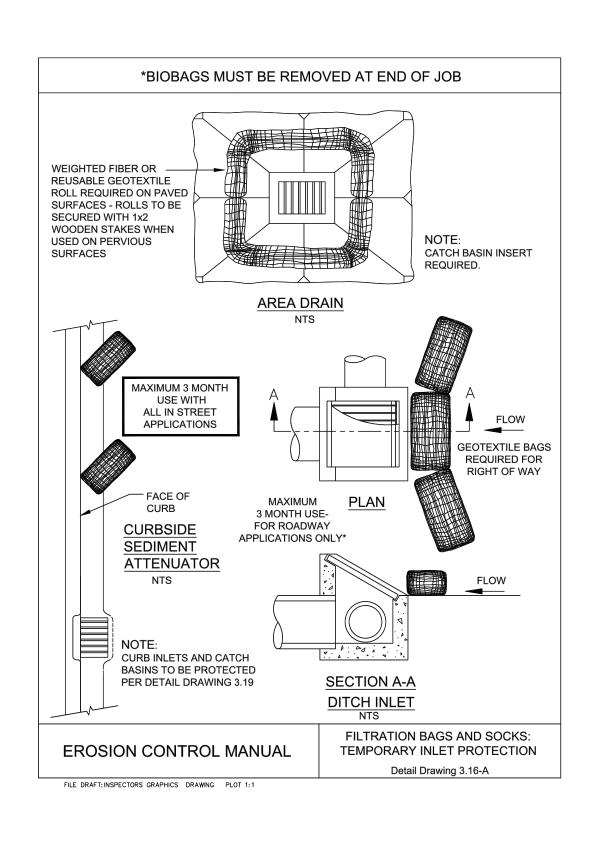

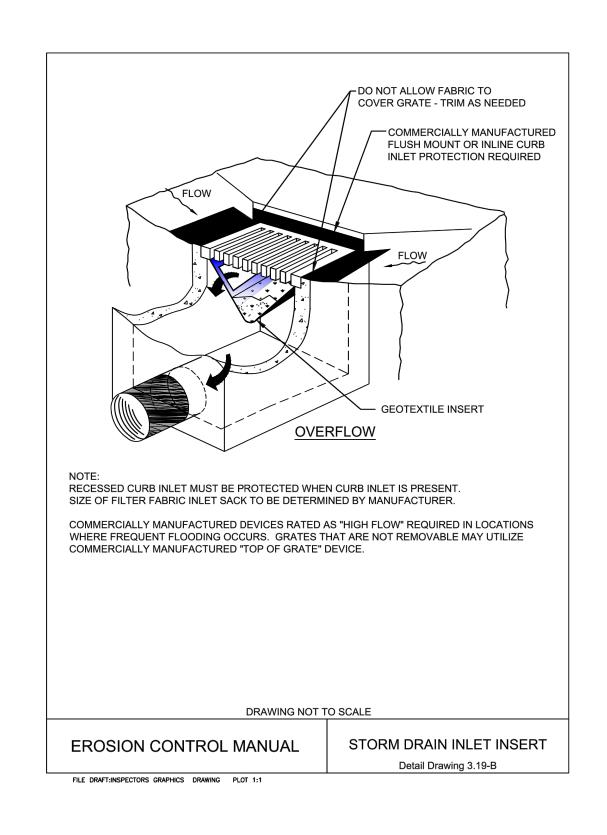

TAILS	REVISIONS	DATE	BY	DESIGNED S. SOKOL
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T: C06				CHECKED C. BUITRAGO
-AYOU				APPROVED

ONE INCH AT FULL SCALE.
IF NOT, SCALE ACCORDINGLY
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JOB No.
273-3324-010
DATE
10/31/25







CHIEF JOSEPH ELEMENTARY
STORMWATER RETROFIT
PORTLAND, OREGON


DETAILS SHEET


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7 OF 10

100 % SUBMITTAL

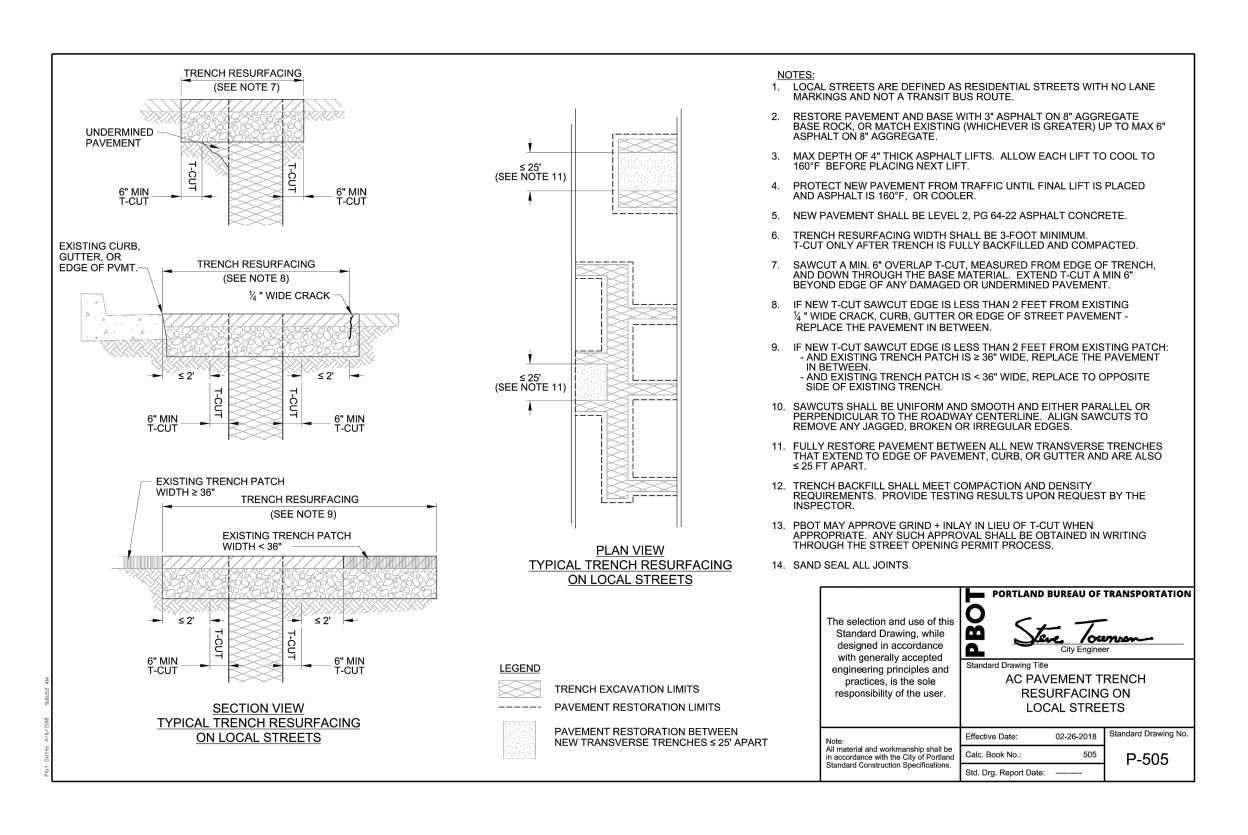

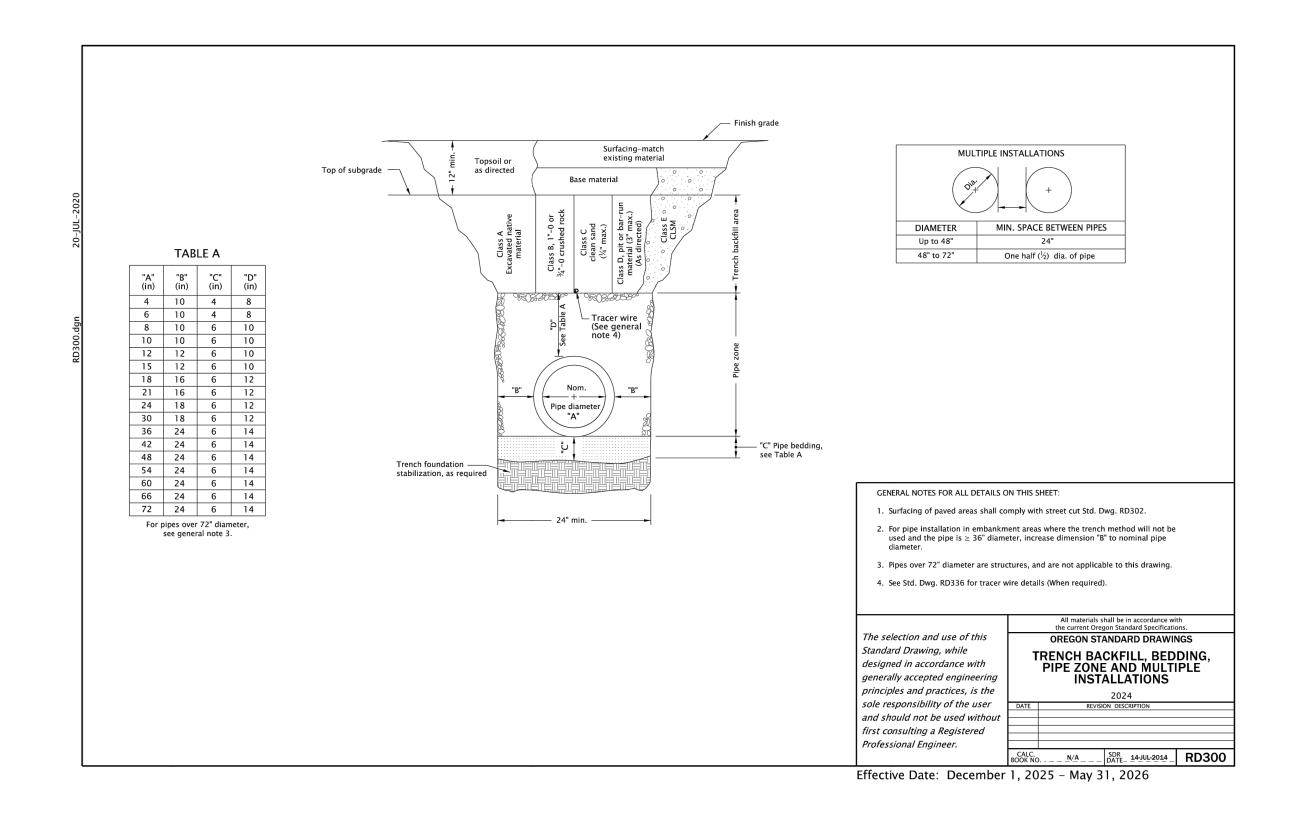

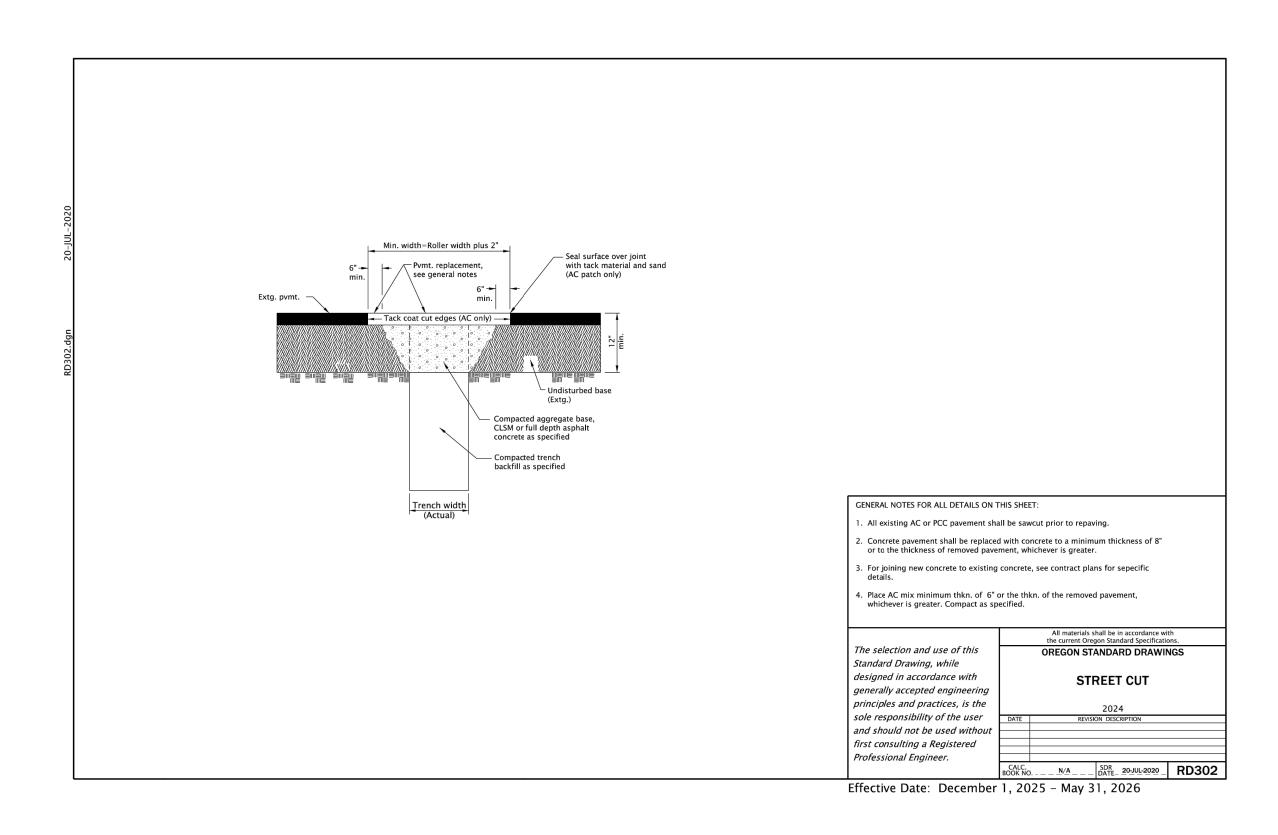

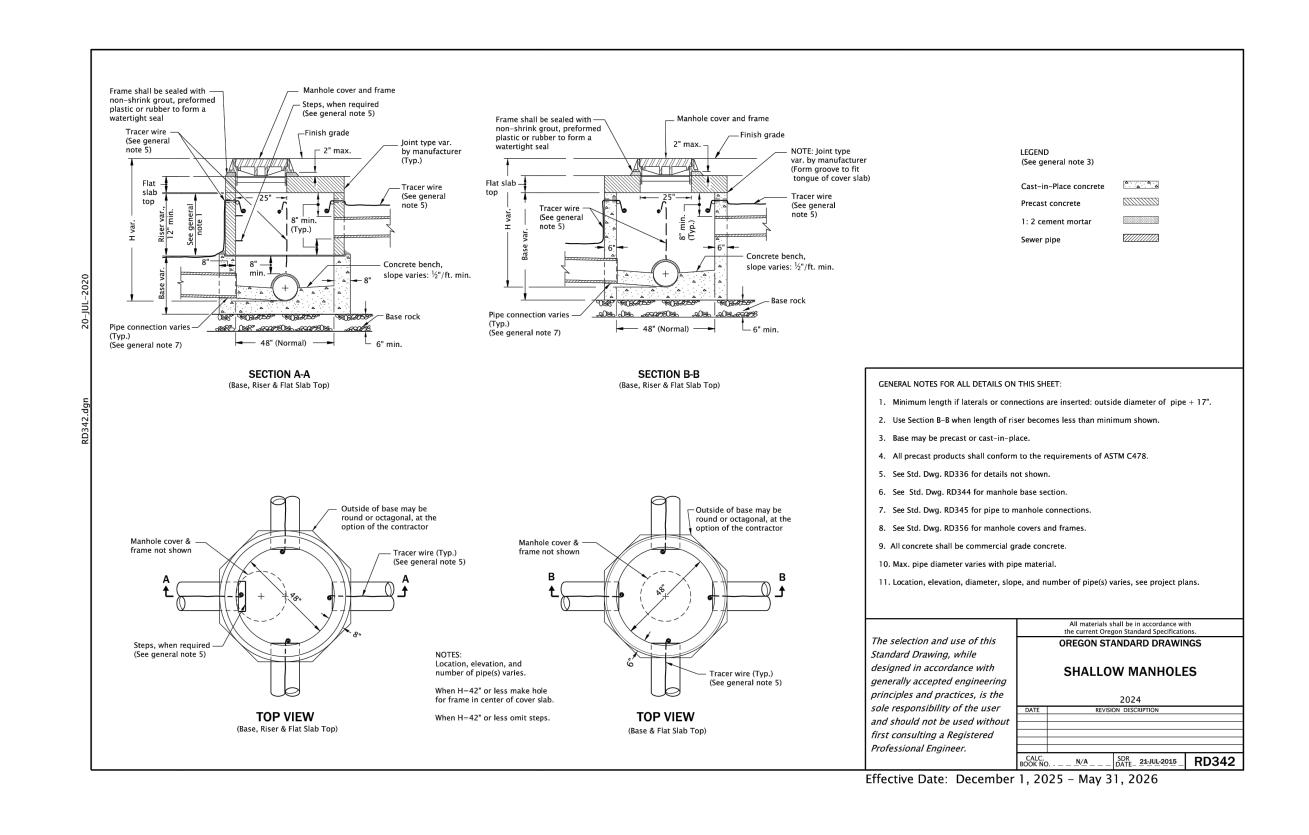

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2				CHECKED
				C. BUITRAGO
70				APPROVED

ONE INCH AT FULL SCALE.
IF NOT, SCALE ACCORDINGLY

FILE NAME
XPO3324010C-DETAIL SHEET
JOB No.
273-3324-010

DATE
10/31/25





CHIEF JOSEPH ELEMENTARY
STORMWATER RETROFIT
PORTLAND, OREGON


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DETAILS SHEET

C07


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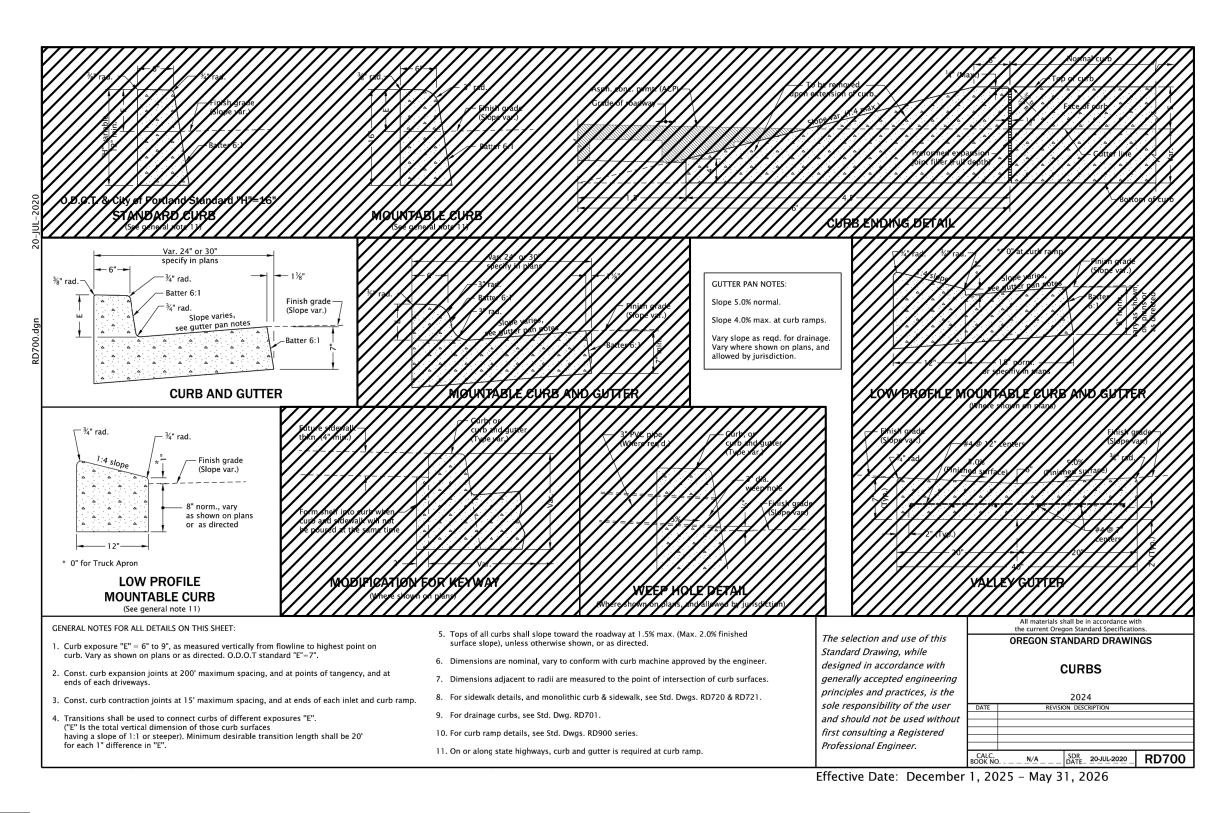
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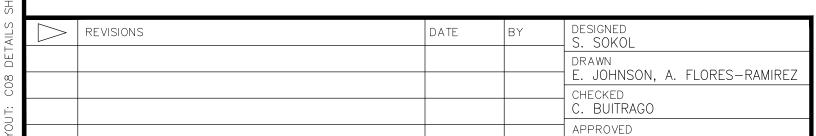


GENERAL NOTES

1. STANDARD DRAWINGS FROM CITY OF PORTLAND AND ODOT ARE PROVIDED IN THIS SHEET. HATCHED AREAS INDICATE NOTES OR DETAILS THAT ARE NOT APPLICABLE AND SHOULD NOT BE USED.

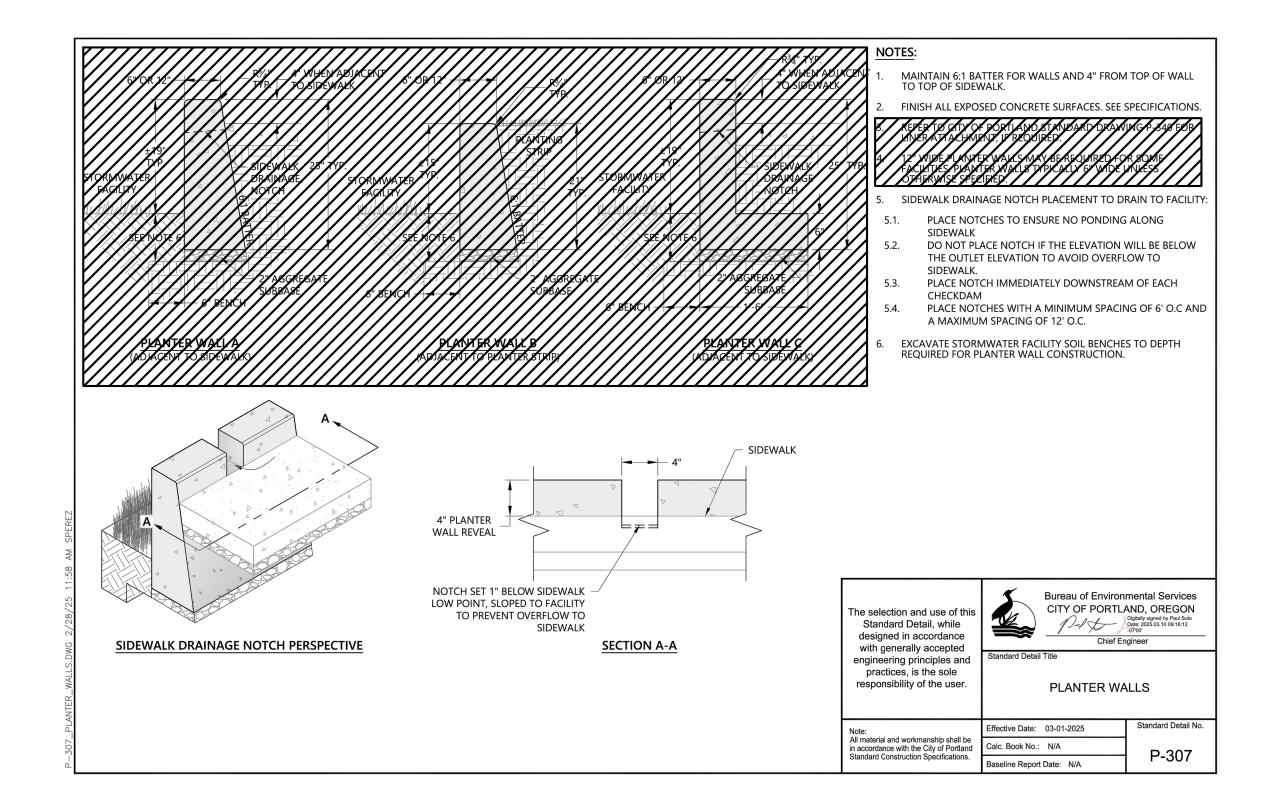



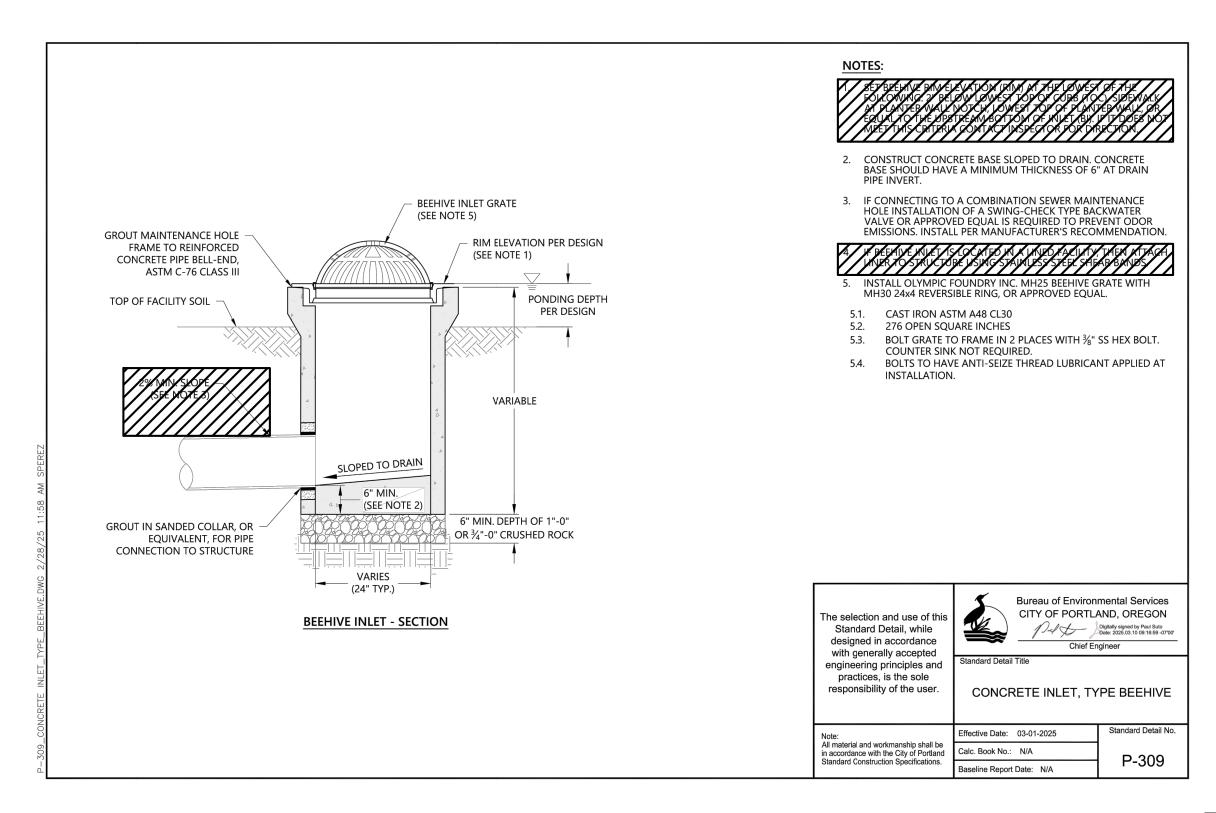

ONE INCH AT FULL SCALE.
IF NOT, SCALE ACCORDINGLY

FILE NAME
XP03324010C-DETAIL SHEETS
JOB No.
273-3324-010

DATE
10/31/25





CHIEF JOSEPH ELEMENTARY
STORMWATER RETROFIT
PORTLAND, OREGON

DETAILS SHEET

DRAWING NO.

9 OF 10

100 % SUBMITTAL


PLANTING NOTES:

- 1. CONTRACTOR IS REQUIRED TO VERIFY EXISTING UTILITY LOCATIONS PRIOR TO CONSTRUCTION.
- 2. CONTRACTOR IS RESPONSIBLE FOR A THOROUGH CLEAN-UP FOR HIS/HER RESPECTIVE WORK, DAILY AND AT PROJECT CLOSE-OUT.
- 3. CONTRACTOR IS RESPONSIBLE FOR PROTECTING ALL EXISTING IMPROVEMENTS. DAMAGE TO THE EXISTING IMPROVEMENTS BY THE CONTRACTOR SHALL BE REPAIRED OR REPLACED BY THE CONTRACTOR AND/OR QUALIFIED INSTALLERS/TRADES ACCEPTABLE TO THE SOLE SATISFACTION OF THE OWNER'S REPRESENTATIVE AND AT NO COST TO THE OWNER.
- 4. PLANT MATERIALS SHALL MEET STANDARDS SET FORTH IN THE LATEST EDITION OF THE AMERICAN ASSOCIATION OF NURSERYMEN STANDARD (ANSI Z60.1) AND OREGON STATE STANDARDS FOR NURSERY STOCK. ALL PLANT MATERIALS SHALL HAVE SUFFICIENT ROOT DEVELOPMENT TO ASSURE SURVIVAL AND HEALTHY GROWTH. CONTAINER GROWN PLANT MATERIALS ARE REQUIRED TO HAVE SUFFICIENT ROOT GROWTH TO HOLD THE SOIL INTACT WHEN REMOVED FROM THE CONTAINER, BUT SHALL NOT BE ROOT BOUND.
- 5. SEE DETAIL 1 THIS SHEET FOR SOIL AMENDMENT INSTALLATION. REFERENCE CIVIL PLANS FOR STORM PLANTER SOIL REQUIREMENTS.
- 6. ALL PLANT MATERIALS AND PLANT LOCATIONS SHALL BE APPROVED BY THE OWNER'S REPRESENTATIVE PRIOR TO INSTALLATION. PLANT LAYOUT SHALL BE SPACED USING TRIANGULAR SPACING OR AS SHOWN ON PLANS. ALL PLANTS SHALL BE THOROUGHLY WATERED IMMEDIATELY AFTER PLANTING.
- 7. CONTRACTOR IS RESPONSIBLE FOR RESTORATION OF ALL INCIDENTAL AREAS DISTURBED DURING CONSTRUCTION.
- 8. NO SUBSTITUTIONS SHALL BE CONSIDERED FOR PLANTS OR OTHER MATERIALS DURING THE BIDDING PROCESS.
- 9. LANDSCAPE MATERIALS & QUANTITIES WILL BE FIELD ADJUSTED TO FIT ACTUAL CONDITIONS IF NECESSARY. COORDINATE LANDSCAPE CONSTRUCTION WITH OWNER'S REPRESENTATIVE.
- 10. SEE CIVIL SHEETS FOR STORM PLANTER CONSTRUCTION AND ADDITIONAL TEMPORARY EROSION AND SEDIMENT CONTROL INFORMATION.


CONSTRUCTION NOTES:


- 1 INSTALL SIX (6) GREY BASALT COLUMNS IN FOREBAY AND FOUR (4) IN NE LANDSCAPED AREA. COLUMNS SHALL BE SELECTED IN A RANGE OF DIAMETERS AND HEIGHTS, WITH MIN. AND MAX. HEIGHTS OF 18" AND 36", RESPECTIVELY, AND MIN. AND MAX. DIAMETERS OF 24" AND 36", RESPECTIVELY. FINAL ARRANGEMENT OF BASALT COLUMNS SHALL BE APPROVED BY THE ESTUARY PARTNERSHIIP PRIOR TO INSTALLATION. BASALT COLUMNS IN FOREBAY SHALL BE INSTALLED IN WET CONCRETE TO THE FULL DEPTH OF THE CONCRETE SECTION. COLUMNS IN BARE DIRT SHALL BE BURIED ¹/₃ DEPTH MIN.
- (2) INSTALL FIVE (5) TIMBERCRAFT 2215 HALF ROUND LOG SEATS IN LOCATIONS SHOWN.
- COBBLE EMBEDDED CONCRETE SHALL USE 1" TO 3" WASHED ROUNDED RIVER ROCK INTENDED FOR DECORATION AND LANDSCAPING. ROCK SHALL BE "PORTLAND ROCK & LANDSCAPE SUPPLY GLACIER RIVER ROCK 1"-3" ", OR EQUAL AS APPROVED BY THE ESTUARY PARTNERSHIP. COBBLE SHALL BE EMBEDDED AT LEAST HALF THEIR DEPTH WITH MAXIMUM REVEAL OF $\frac{1}{4}$ IN. STONES SHALL BE RANDOMLY LAID (NOT COURSED) AND SPACED AS TIGHTLY AS PRACTICABLE (TARGET SPACING $\frac{1}{8}$ TO $\frac{1}{4}$ IN). SLURRY JOINT TO FILL GAPS. WASH COBBLES CLEAN WITH SPONGE AND WATER BEFORE SLURRY FULLY SETS.

SEQUENCE OF WORK:

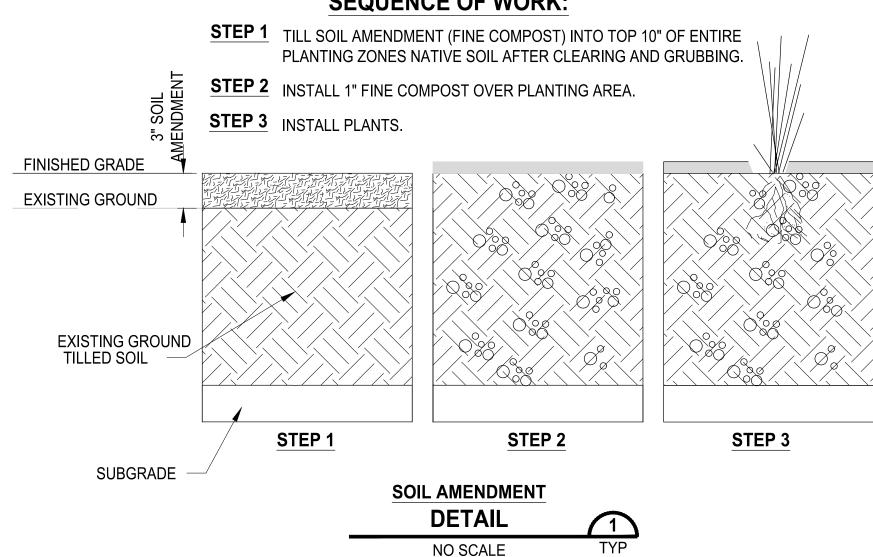

REVISIONS	DATE	BY	DESIGNED D. BAILEY	
			DRAWN D. BAILEY	?ES−RAMIREZ
			CHECKED C. BUITRAGO	
			APPROVED	

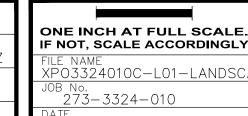

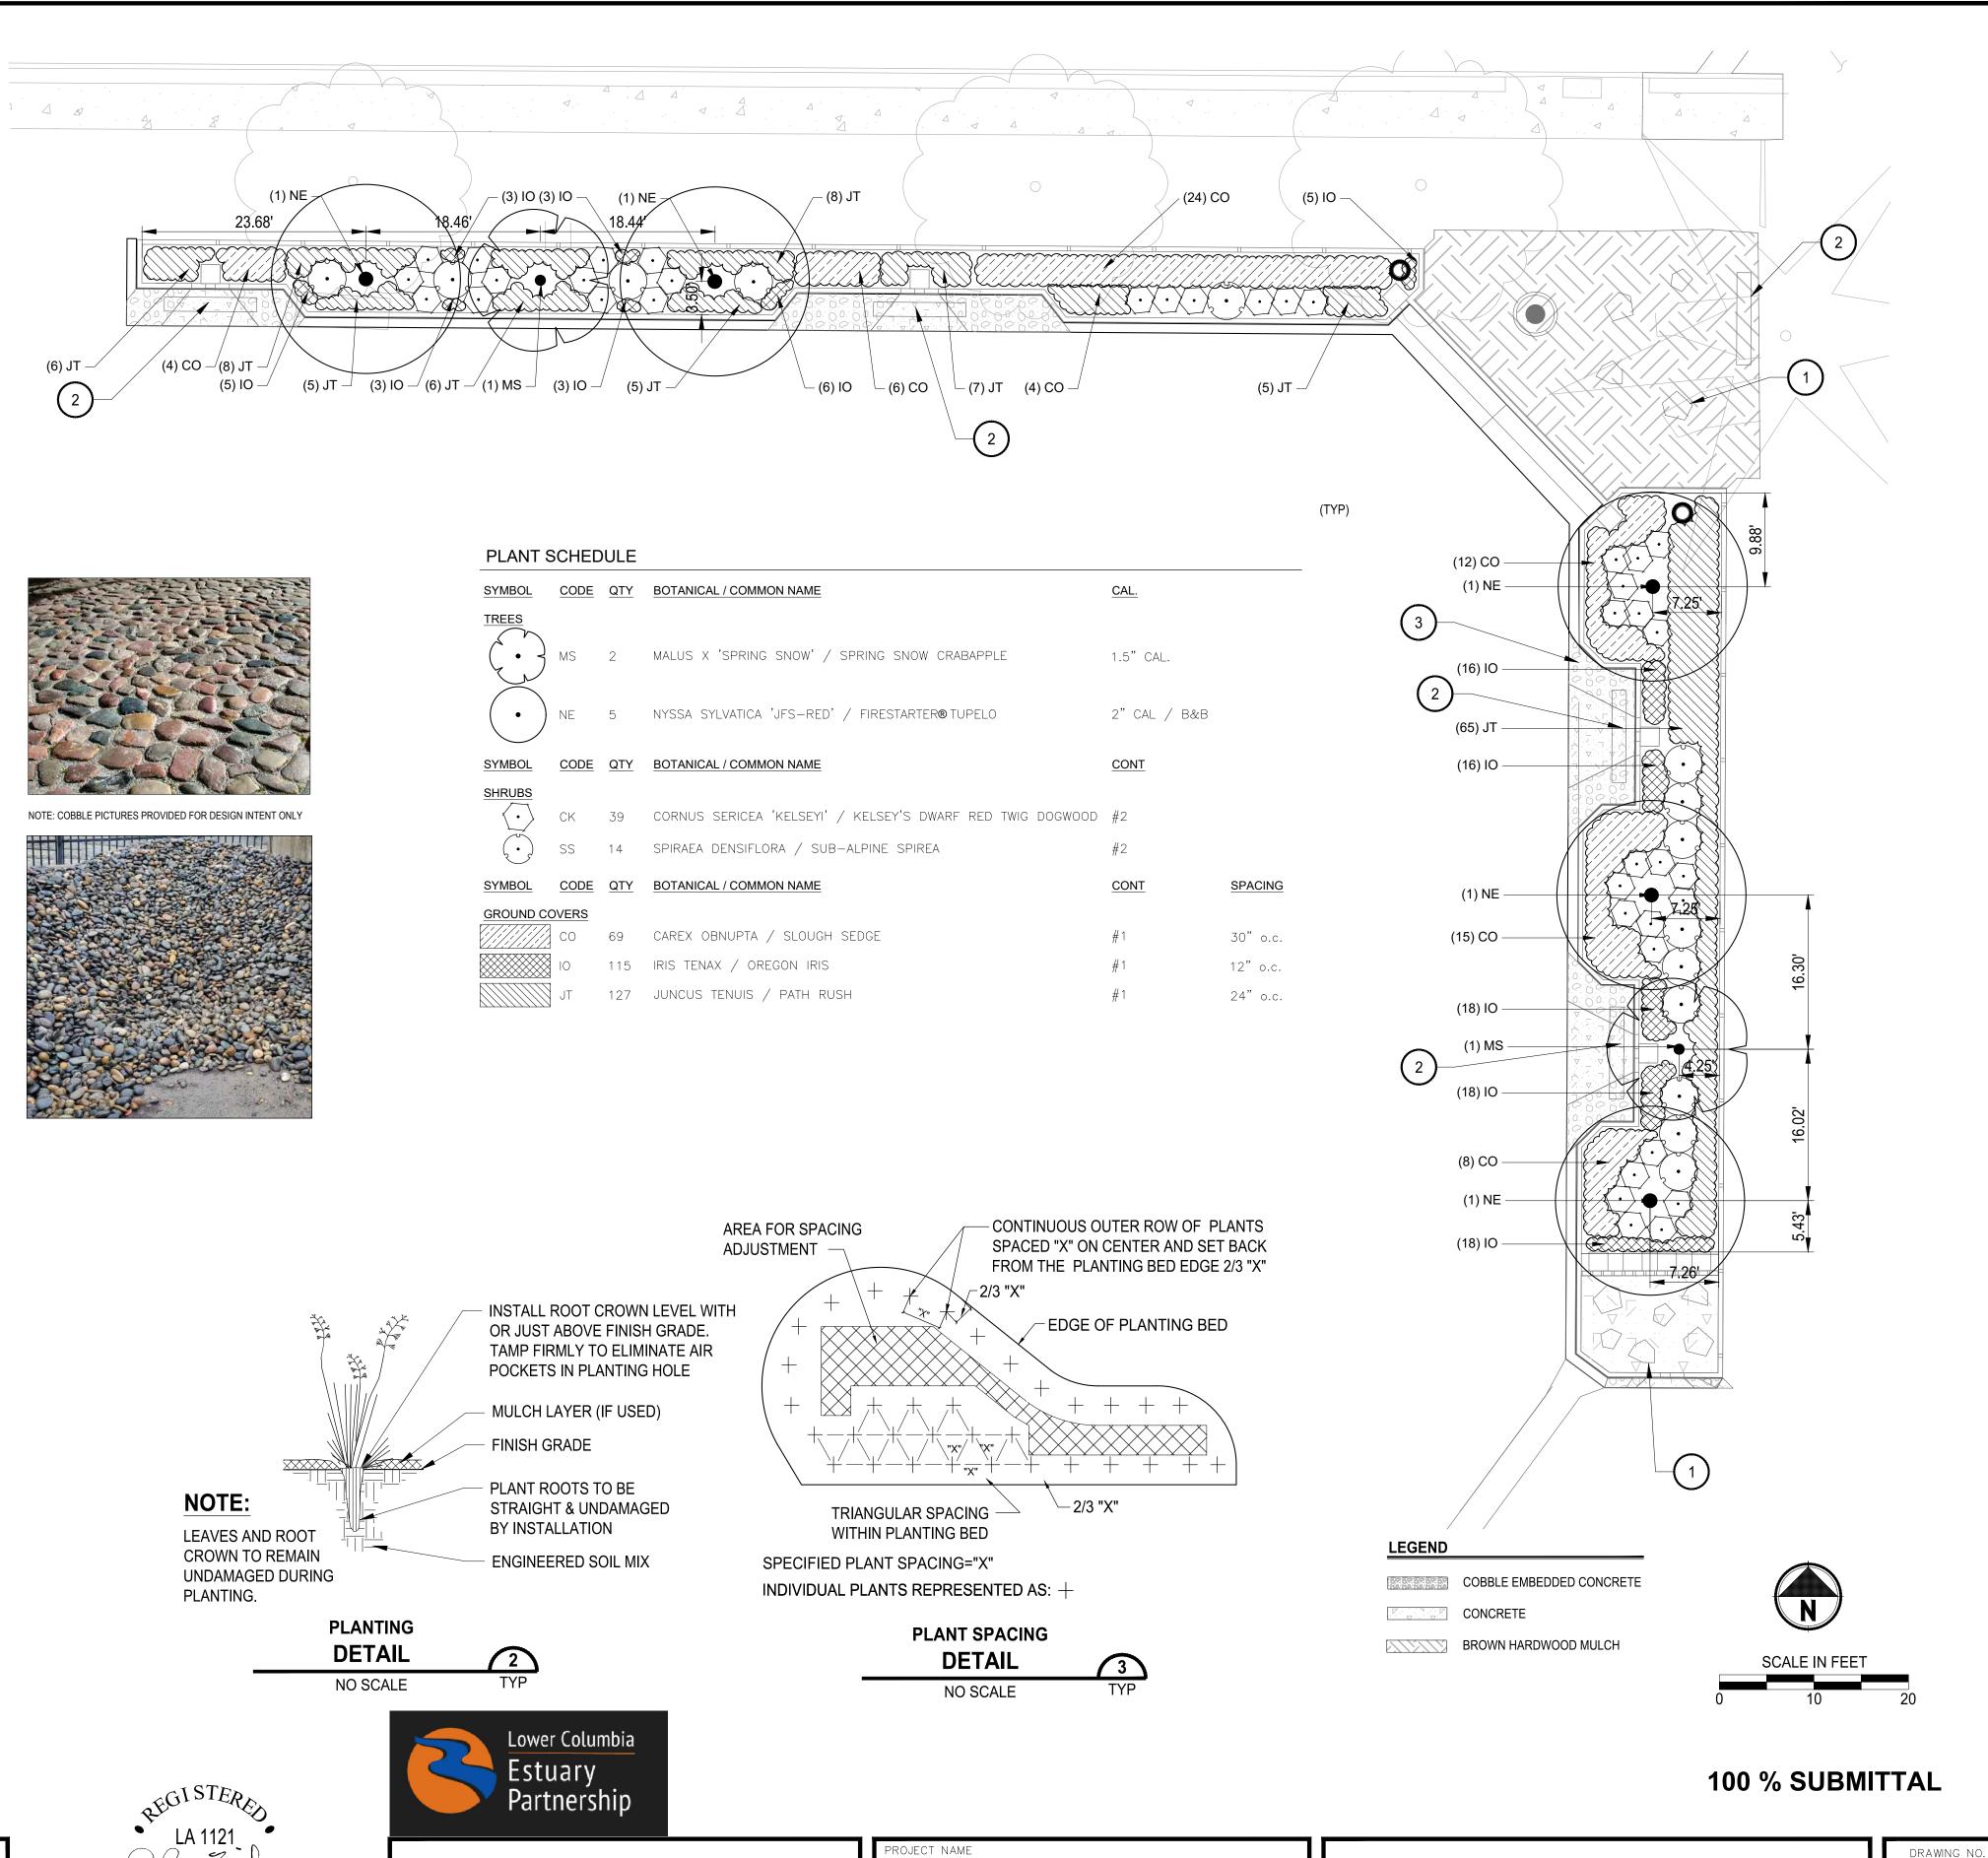

CHIEF JOSEPH ELEMENTARY

STORMWATER RETROFIT

PORTLAND, OREGON

Parametrix

OREGON OP/30/26

OREGON
OP/30/26

OREGON
OP/ARCHIE

LANDSCAPE PLAN

10 OF 10

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